
340-376 Dufferin St.

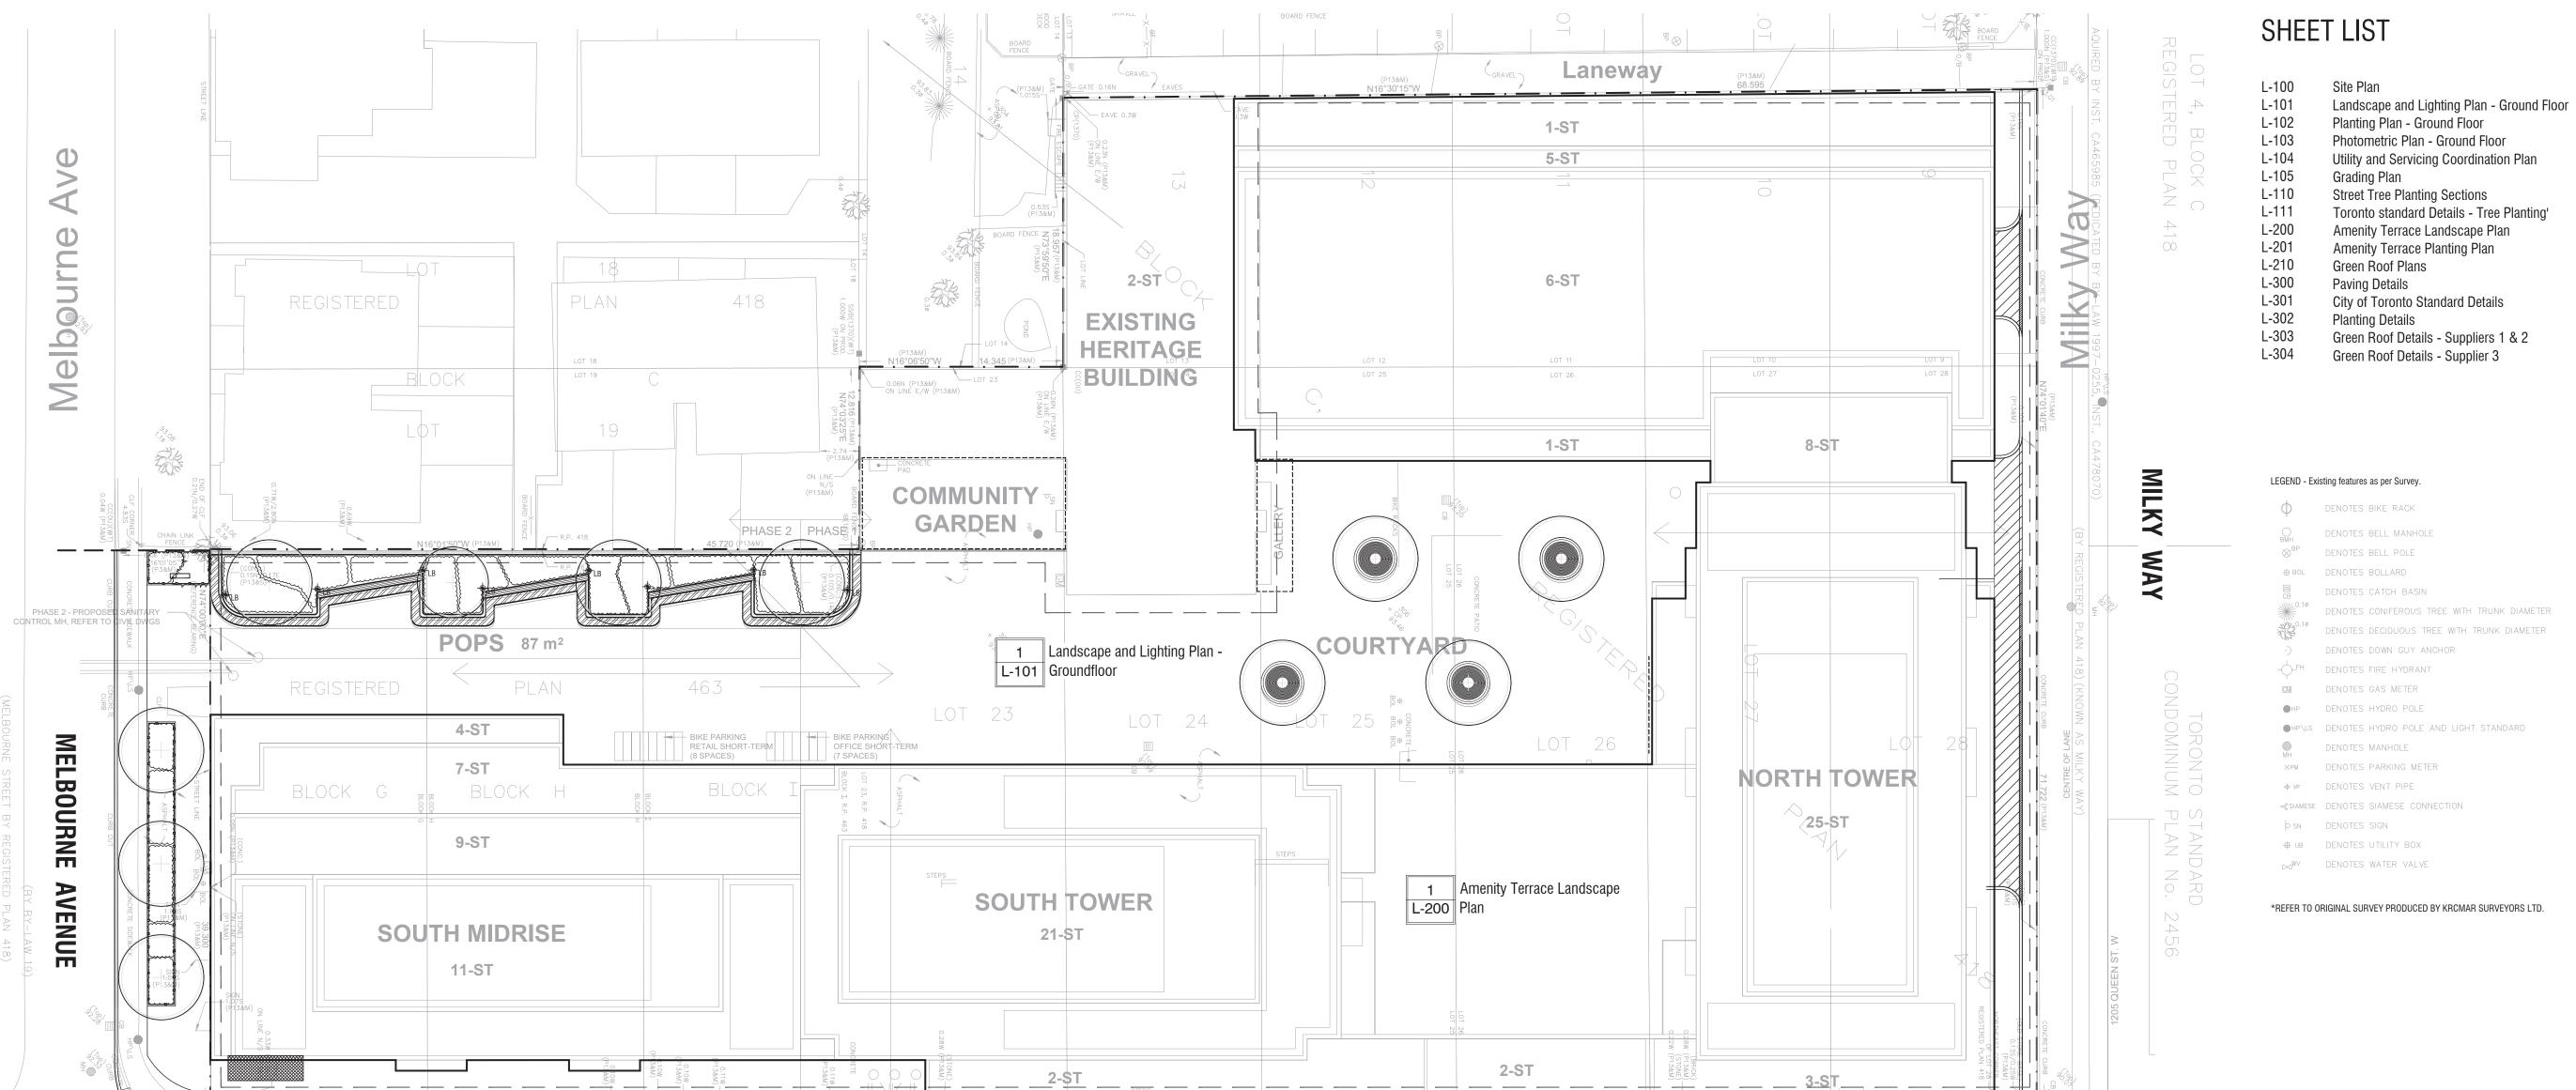

DUFFERIN STREET

PROPOSED STORM CONTROL MH, —— REFER TO CIVIL DWGS

Tree Canopy

Total Soil Volume (40% of the site area ÷ 66 m2 x 30 m³)

Soil Volume provided within the public boulevard (m³)

Available Roof Space provided as Solar Panels (m²)

Soil volume provided within the site area (m³)

7. Drawings and specifications are the property of the Landscape Architect, and must be returned upon completion of the work

GENERAL NOTES

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Architect - Sweeny & Co.

Planner - Bousfields Inc.

Mech Eng -

Interior -

Civil Eng - R. V. Anderson Associates

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landscape ar consteç

SITE PLAN

TORONTO GREEN STANDARDS VERSION 4.0 MID TO HIGH-RISE RESIDENTIAL



Nothber of strade frees located in softace parking area	INA	INA	IVA	
Landscaping & Biodiversity	Required	Proposed	Proposed %	
Total non-roof hardscape area (m²)	n/a	1426	100%	
Total non-roof hardscape area treated for Urban Heat Island (minimum residential 75% or non-residential 50%) (m²)	1070	1101	77%	
Area of non-roof hardscape treated with: (indicate m²)	N/A	N/A	N/A	
a) high-albedo surface material	N/A	1101	77%	
b) open-grid pavement	N/A	N/A	N/A	
c) shade from tree canopy	N/A	N/A	N/A	

Landscaping & Biodiversity	Required	Proposed	Proposed %
d) shade from high-albedo structures	N/A	N/A	N/A
e) shade from energy generation structures	N/A	N/A	N/A
Percentage of Lot Area as Soft Landscaping (non-residential only)	N/A	N/A	N/A
Total number of plants	N/A	723	N/A
Total number of native plants and % of total plants	362	429	100%
Available Roof Space (m²)	_	3,164	
Available Roof Space provided as Green Roof (m²)	1,898.4	1,898.4	60
Available Roof Space provided as Cool Roof (m²)	-	_	*

P-RE-519-15

1353.5m³

33% 67%

Proposed Proposed %

774.3m³


256.9m3

517.4m³

DESCRIPTION

Site Plan


INITIAL

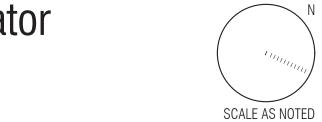



SITE



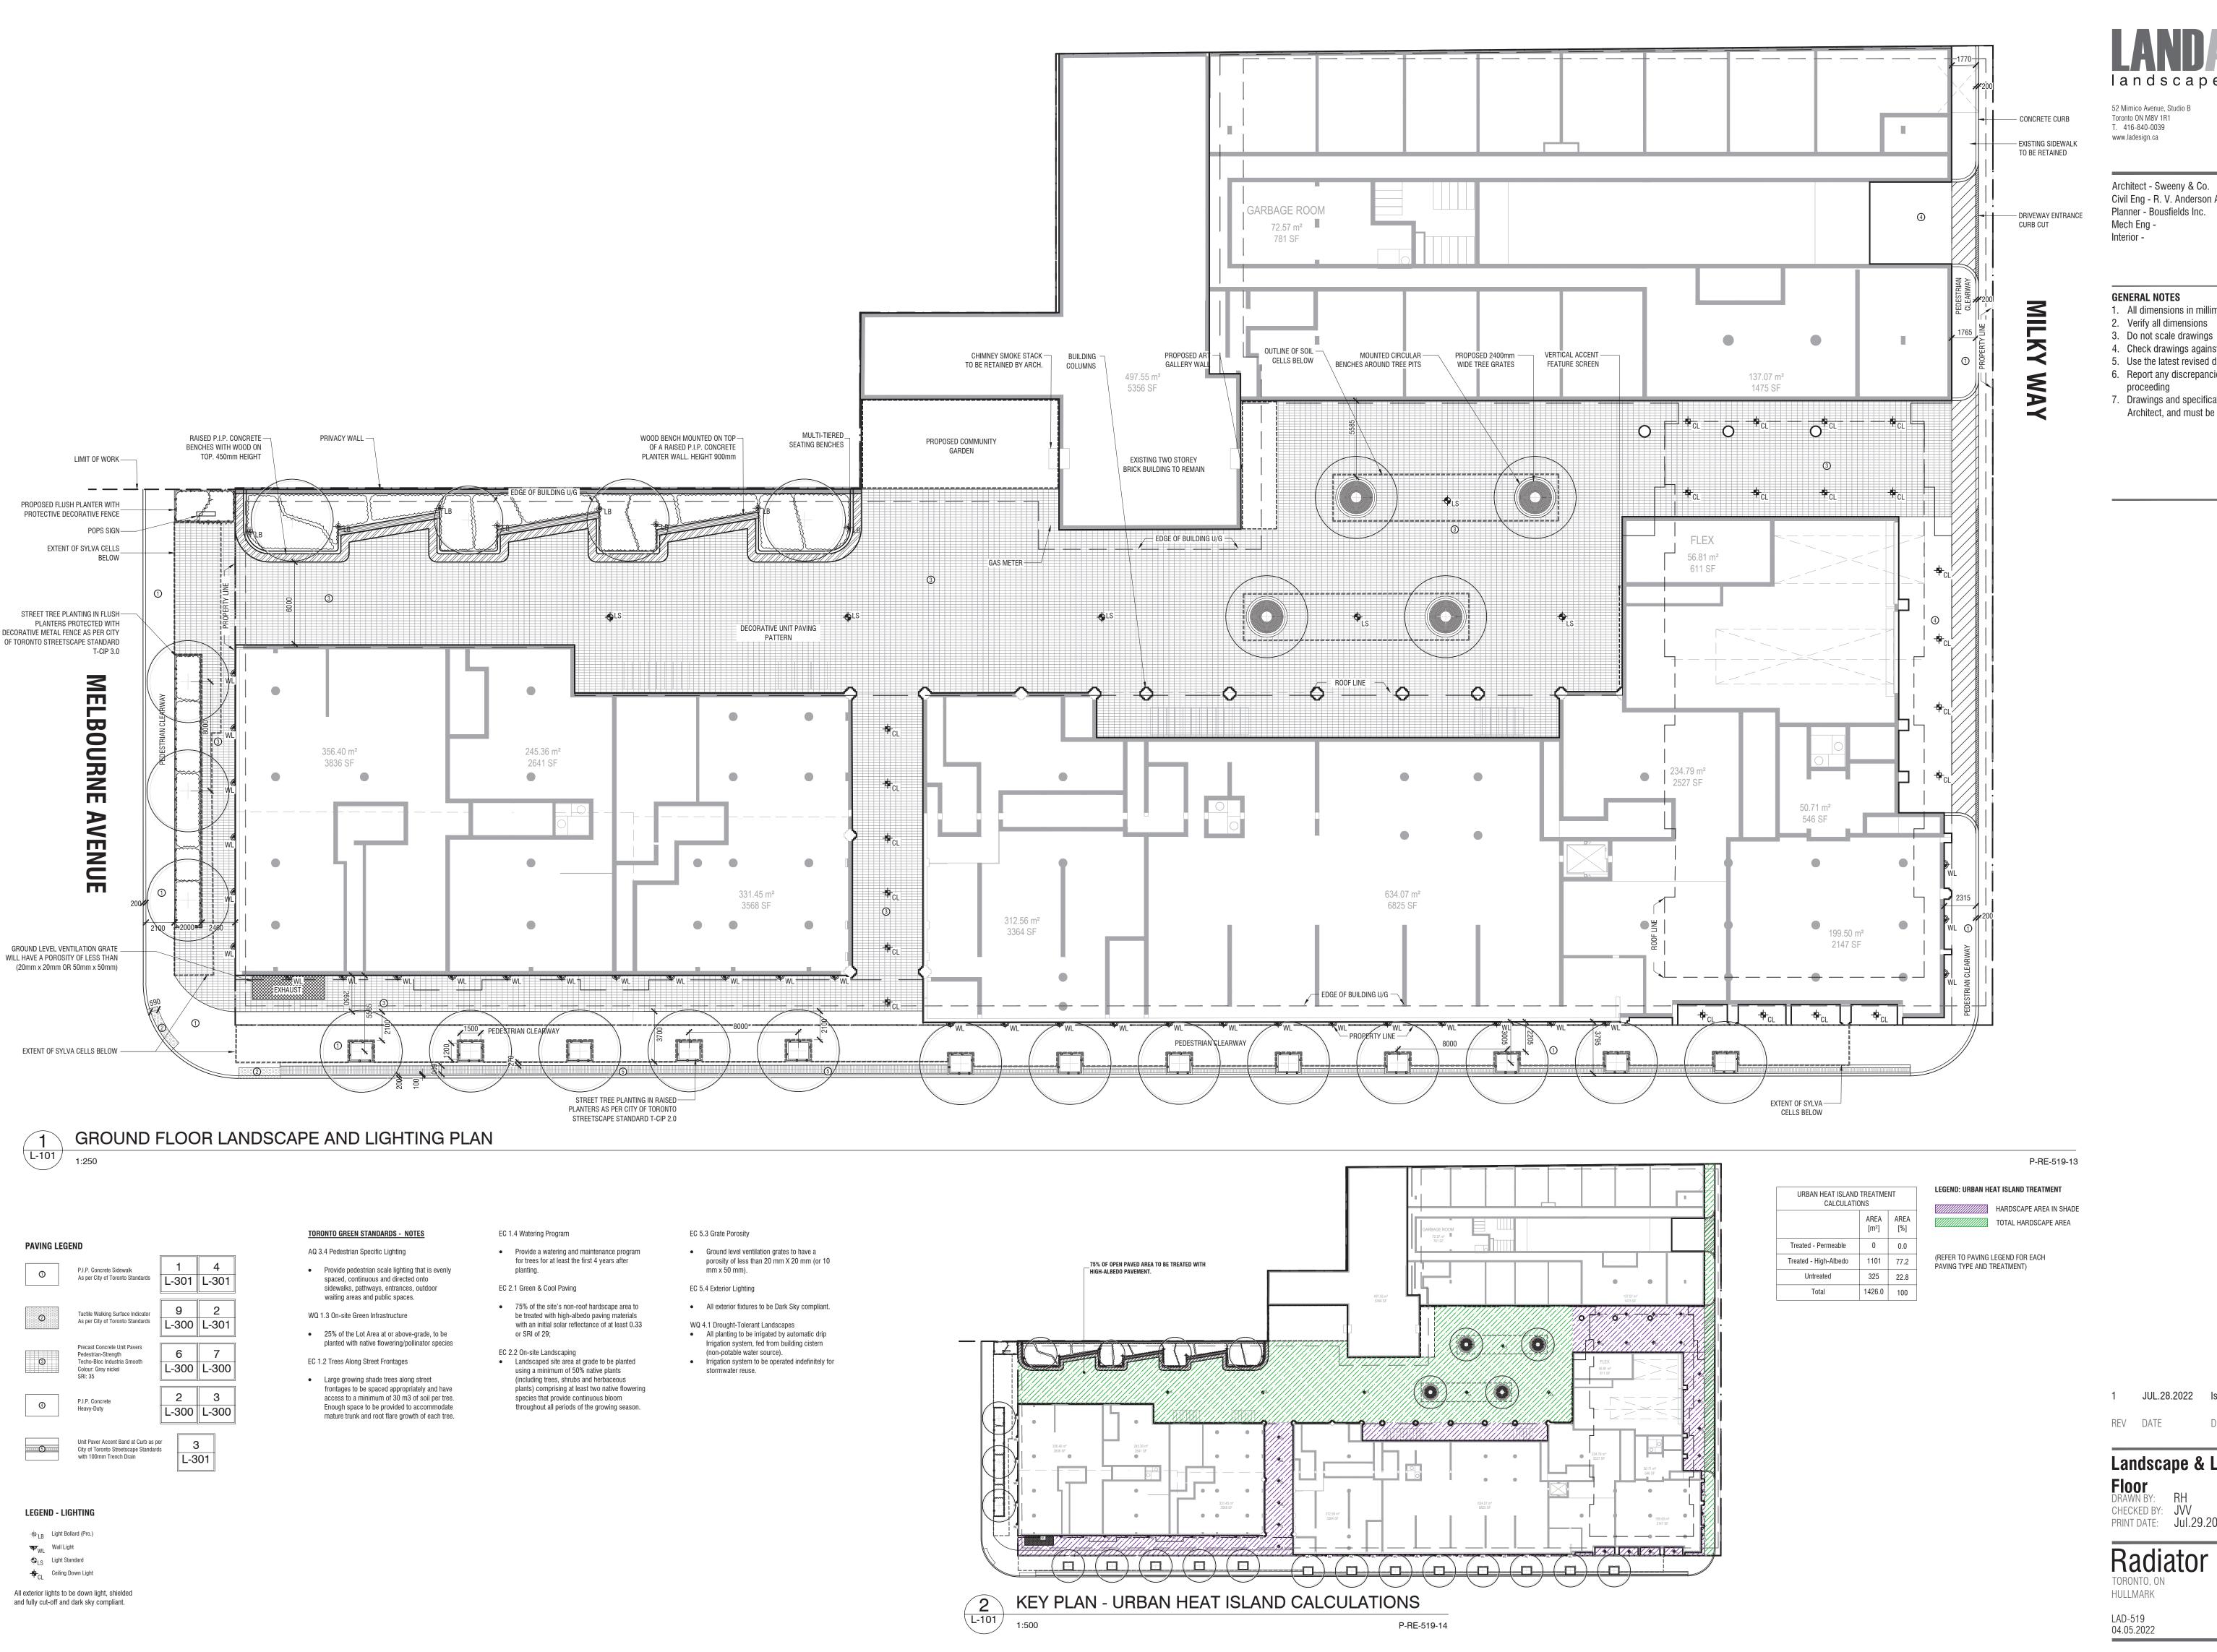

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Architect - Sweeny & Co. Civil Eng - R. V. Anderson Associates Planner - Bousfields Inc. Mech Eng -

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DESCRIPTION

INITIAL


Landscape & Lighting Plan - Ground

CHECKED BY: JVV

PRINT DATE: Jul.29.2022


TORONTO, ON

SCALE AS NOTED

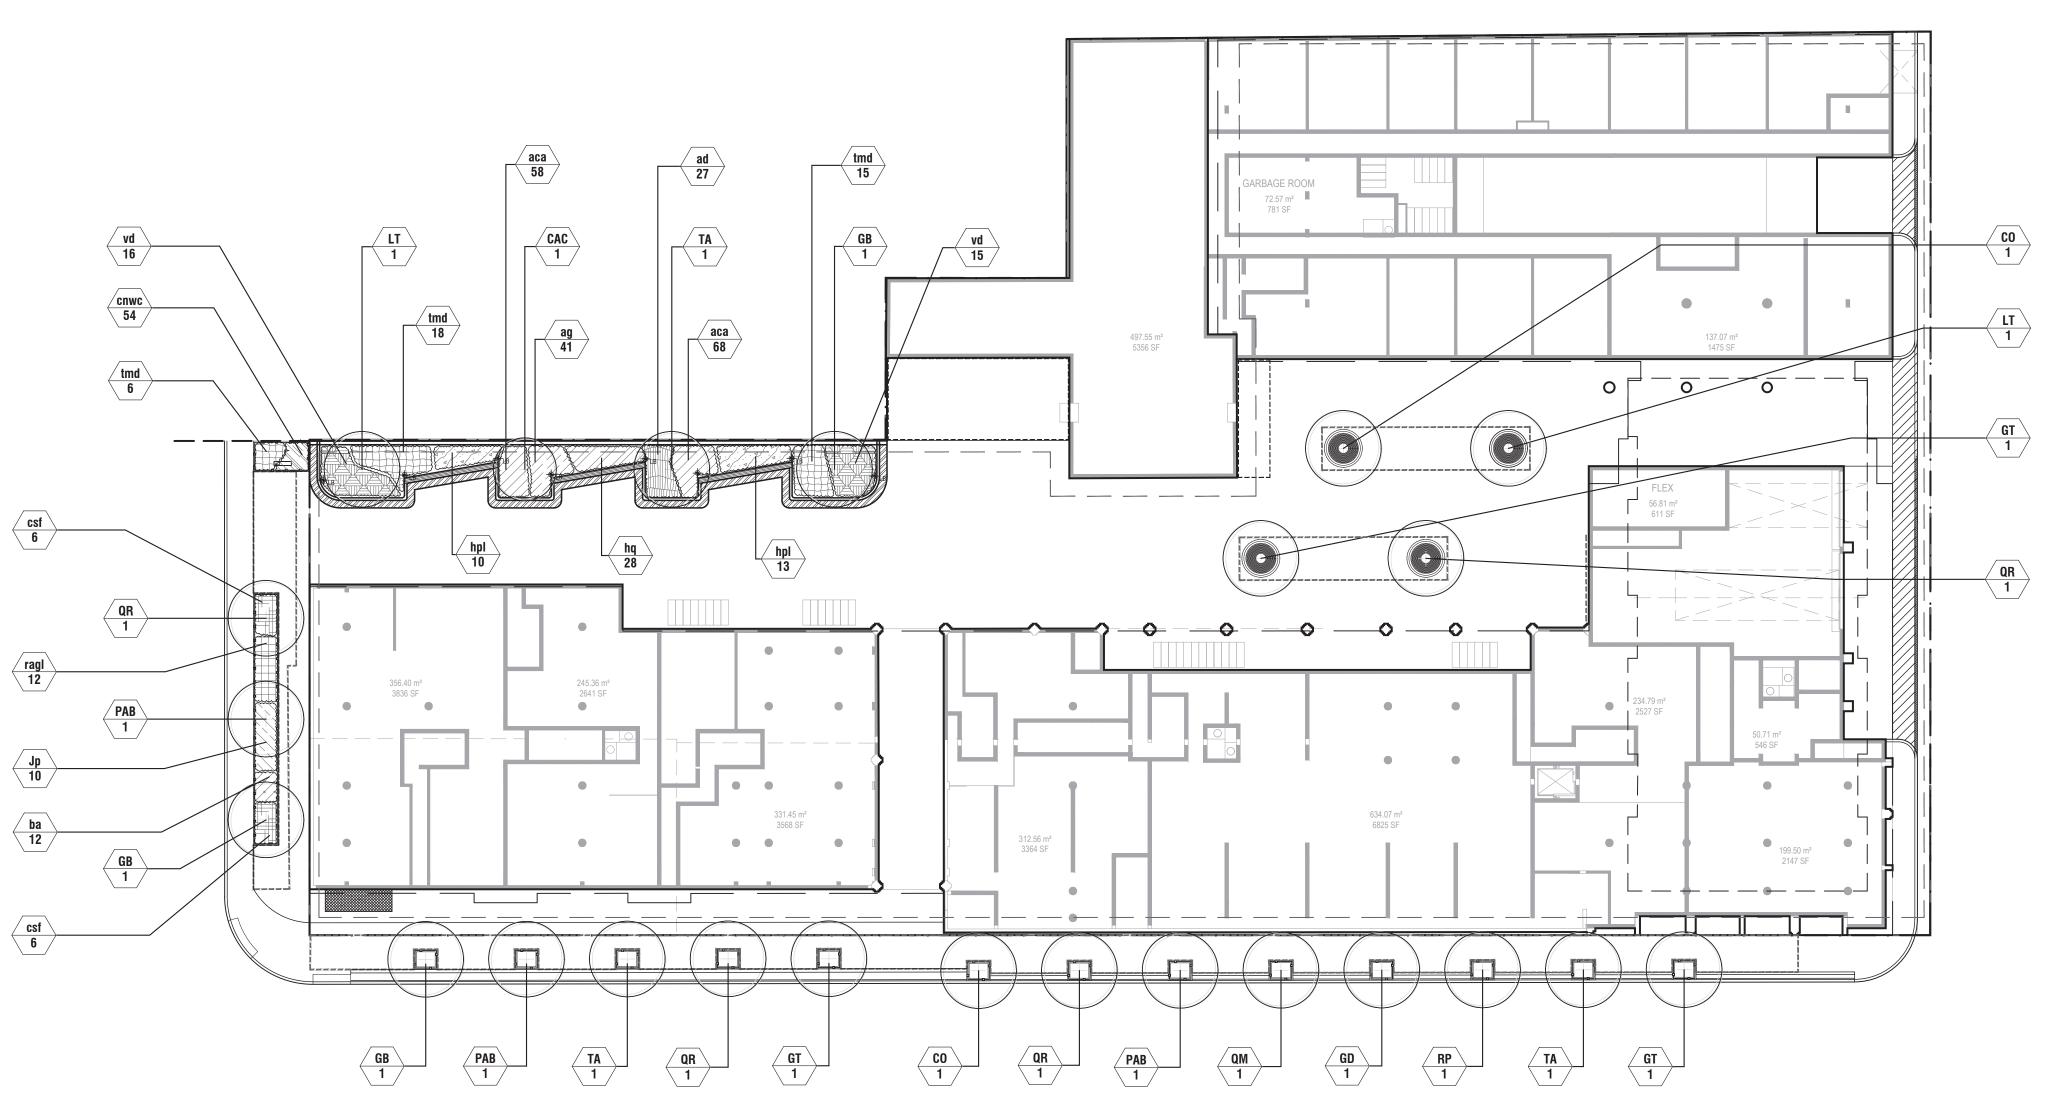

GROUND FLOOR PLANTING PLAN

P-RE-519-07

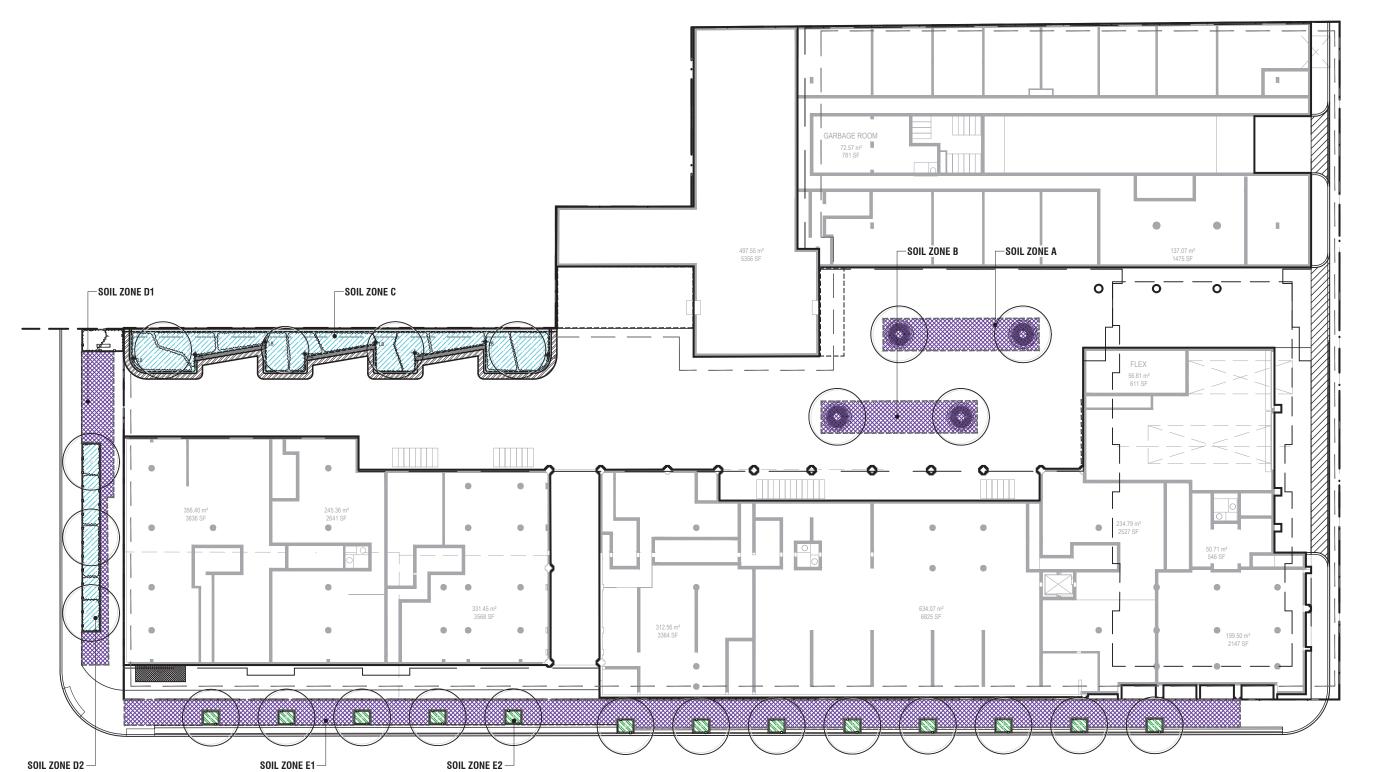

DI ANT SCHEDI II E

PLANT SCHEDUL	.E									
DECIDUOUS TREES	QTY	BOTANICAL NAME	COMMON NAME	CONT	<u>CAL</u> 70mm Cal.	SIZE	NATIVE	DROUGHT		REMARKS
CAC	1	Carpinus caroliniana	American Hornbeam	W.B.	70mm Cal.		Native	Yes		
CO	2	Celtis occidentalis	Common Hackberry	W.B.	70mm Cal.		Native	Yes		
GB	3	Ginkgo biloba	Maidenhair Tree	W.B.	70mm Cal.			Yes		
GT	3	Gleditsia triacanthos inermis `Shademaster`	Shademaster Locust	W.B.	70mm Cal.			Yes		
GD	1	Gymnocladus dioica	Kentucky Coffeetree	W.B.	70mm Cal.		Native	Yes		
LT	2	Liriodendron tulipifera	Tulip Poplar	W.B.	70mm Cal.		Native	Yes		
QM	1	Quercus macrocarpa	Burr Oak	W.B.	70mm Cal.		Native	Yes		Spring-Dug Only
QR	4	Quercus rubra	Red Oak	W.B.	70mm Cal.		Native	Yes		Spring-Dug Only
RP	1	Robinia pseudoacacia	Black Locust	W.B.	70mm Cal.			Yes		
TA	3	Tilia americana	American Linden	W.B.	70mm Cal.		Native	Medium		
LARGE STATURE TREES (LST)	QTY 3	BOTANICAL NAME	COMMON NAME	CONT	<u>CAL</u> 50mm Cal.	SIZE	NATIVE	DROUGHT		REMARKS
PAB	3	Platanus x acerifolia `Bloodgood`	London Plane Tree	W.B.	50mm Cal.					
DECIDUOUS SHRUBS	QTY 12	BOTANICAL NAME	COMMON NAME	CONT	SIZE	NATIVE	DROUGHT		SPACING	
csf	12	Cornus sericea `Flaviramea`	Yellow Twig Dogwood	Potted	500mm Ht.	Native			1000mm	
hpl	23	Hydrangea paniculata `Limelight`	Limelight Hydrangea	Potted	300mm Ht.				900mm	
hq	28	Hydrangea quercifolia 'Alice'	Alice Oakleaf Hydrangea	Potted	500mm Ht.	Native	Yes		600mm	
ragl	12	Rhus aromatica `Gro-Low`	Gro-Low Fragrant Sumac	Potted	500mm Ht.		Yes		900mm	
vd	31	Viburnum dentatum	Viburnum	Potted	500mm Ht.	Native			1000mm	
EVERGREEN SHRUBS	QTY 10	BOTANICAL NAME	COMMON NAME	CONT	SIZE	NATIVE	DROUGHT		SPACING	
Jp	10	Juniperus chinensis 'Pfitzeriana'	Pfitzer Juniper	Potted	500mm Ht.		Yes		1000mm	
tmd	39	Taxus x media `Densiformis`	Dense Yew	Potted	500mm Ht.				900mm	
PERENNIALS	QTY	BOTANICAL NAME	COMMON NAME	CONT	SIZE	NATIVE	DROUGHT		SPACING	
ag	41	Agastache foeniculum 'Golden Jubilee'	Golden Jubilee Giant Hyssop	1 gal	2 yr. gr.	Native	Yes		500mm	
aca	126	Anemone canadensis	Canadian Anemone	1 gal	2 yr. gr.	Native			400mm	
ad	27	Aster divaricatus	White Wood Aster	1 gal. potted	2 yr. growth	Native			600mm	
ba	12	Baptisia australis	Blue Wild Indigo	1 gal. potted	2 yr. growth	Native	Yes		600mm	
cnwc	54	Calamintha nepeta 'White Cloud'	White Cloud Lesser Calamint	1 gal. potted	2 yr. growth		Yes		300mm	

LEGEND - Soil Volumes

Soil Cells below Paving To conform to City Specifications 1.1m soil depth (typ.)



Tree Opening



		80	IL VOLUME CALC	CULATIONS			
SOIL ZONE	ТҮРЕ	AREA (m²)	DEPTH (m)	VOLUME (m³)	SUBTOTAL	# of TREES	VOLUME/TREE
А	Soil Cells under Courtyard	56.1	1.20	67.3	67.3	2	33.7
В	Soil Cells under Courtyard	56.1	1.20	67.3	67.3	2	33.7
С	Open Planting Bed	135.9	0.90	122.3	122.3	4	30.6
D1	Soil Cells under Sidewalk	61.7	1.20	74.0			
D2	Open Planting Bed	39.7	1.20	47.6			
				ZONE D1+D2:	121.7	3	40.6
E1	Soil Cells under Sidewalk	306.3	1.20	367.6			
E2	Tree Opening	23.4	1.20	28.1			
				ZONE E1+E2:	395.6	13	30.43
	S	OIL VOLUME PROVI	DED AT GRADE	774.3			
		TOTAL SOIL VOL	JME PROVIDED		774.3		
(BASED	ON SITE AREA OF 7444m² AF		UME REQUIRED S AND CORNER		1353.5		

TREE PLANTING NOTES:

Owner will plant all new trees within the city road allowances to the satisfaction of the general manager of Parks, Forestry & Recreation, and in accordance with "Tree Planting Solutions in Hard Boulevard Surfaces" Best Practices Manual.

A Watering program will be provided for trees at least for the first 4 years after planting.


Soil for all tree planting shall conform to the following the City standard: a sandy loam texture profile (with 50-60% sand, 20-40% silt, and 6-10% clay, 2-5% organic matter by dry weight, and a maximum pH of 7.5.

SOIL VOLUME REQUIREMENTS:

TOTAL SITE AREA: 7444m²

SOIL VOLUME REQUIRED: 1353.5m³ (TOTAL SITE AREA ÷ 66m² x 40% x 30m³)

KEY PLAN - SOIL VOLUME CALCULATIONS

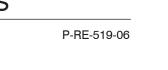



INITIAL

1 JUL.28.2022 Issued for ZBA/SPA

Ground Floor Planting Plan

DESCRIPTION

REV DATE

DRAWN BY: RH CHECKED BY: JVV

PRINT DATE: Jul.29.2022

52 Mimico Avenue, Studio B Toronto ON M8V 1R1 T. 416-840-0039

Architect - Sweeny & Co.

Planner - Bousfields Inc.

GENERAL NOTES

2. Verify all dimensions 3. Do not scale drawings

Civil Eng - R. V. Anderson Associates

1. All dimensions in millimetres (mm)


4. Check drawings against specifications 5. Use the latest revised drawings only

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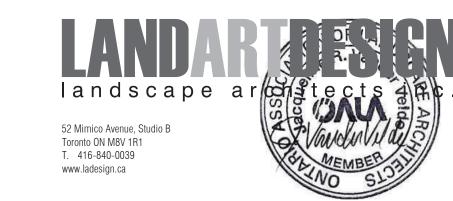
7. Drawings and specifications are the property of the Landscape Architect, and must be returned upon completion of the work

www.ladesign.ca

Mech Eng -Interior -



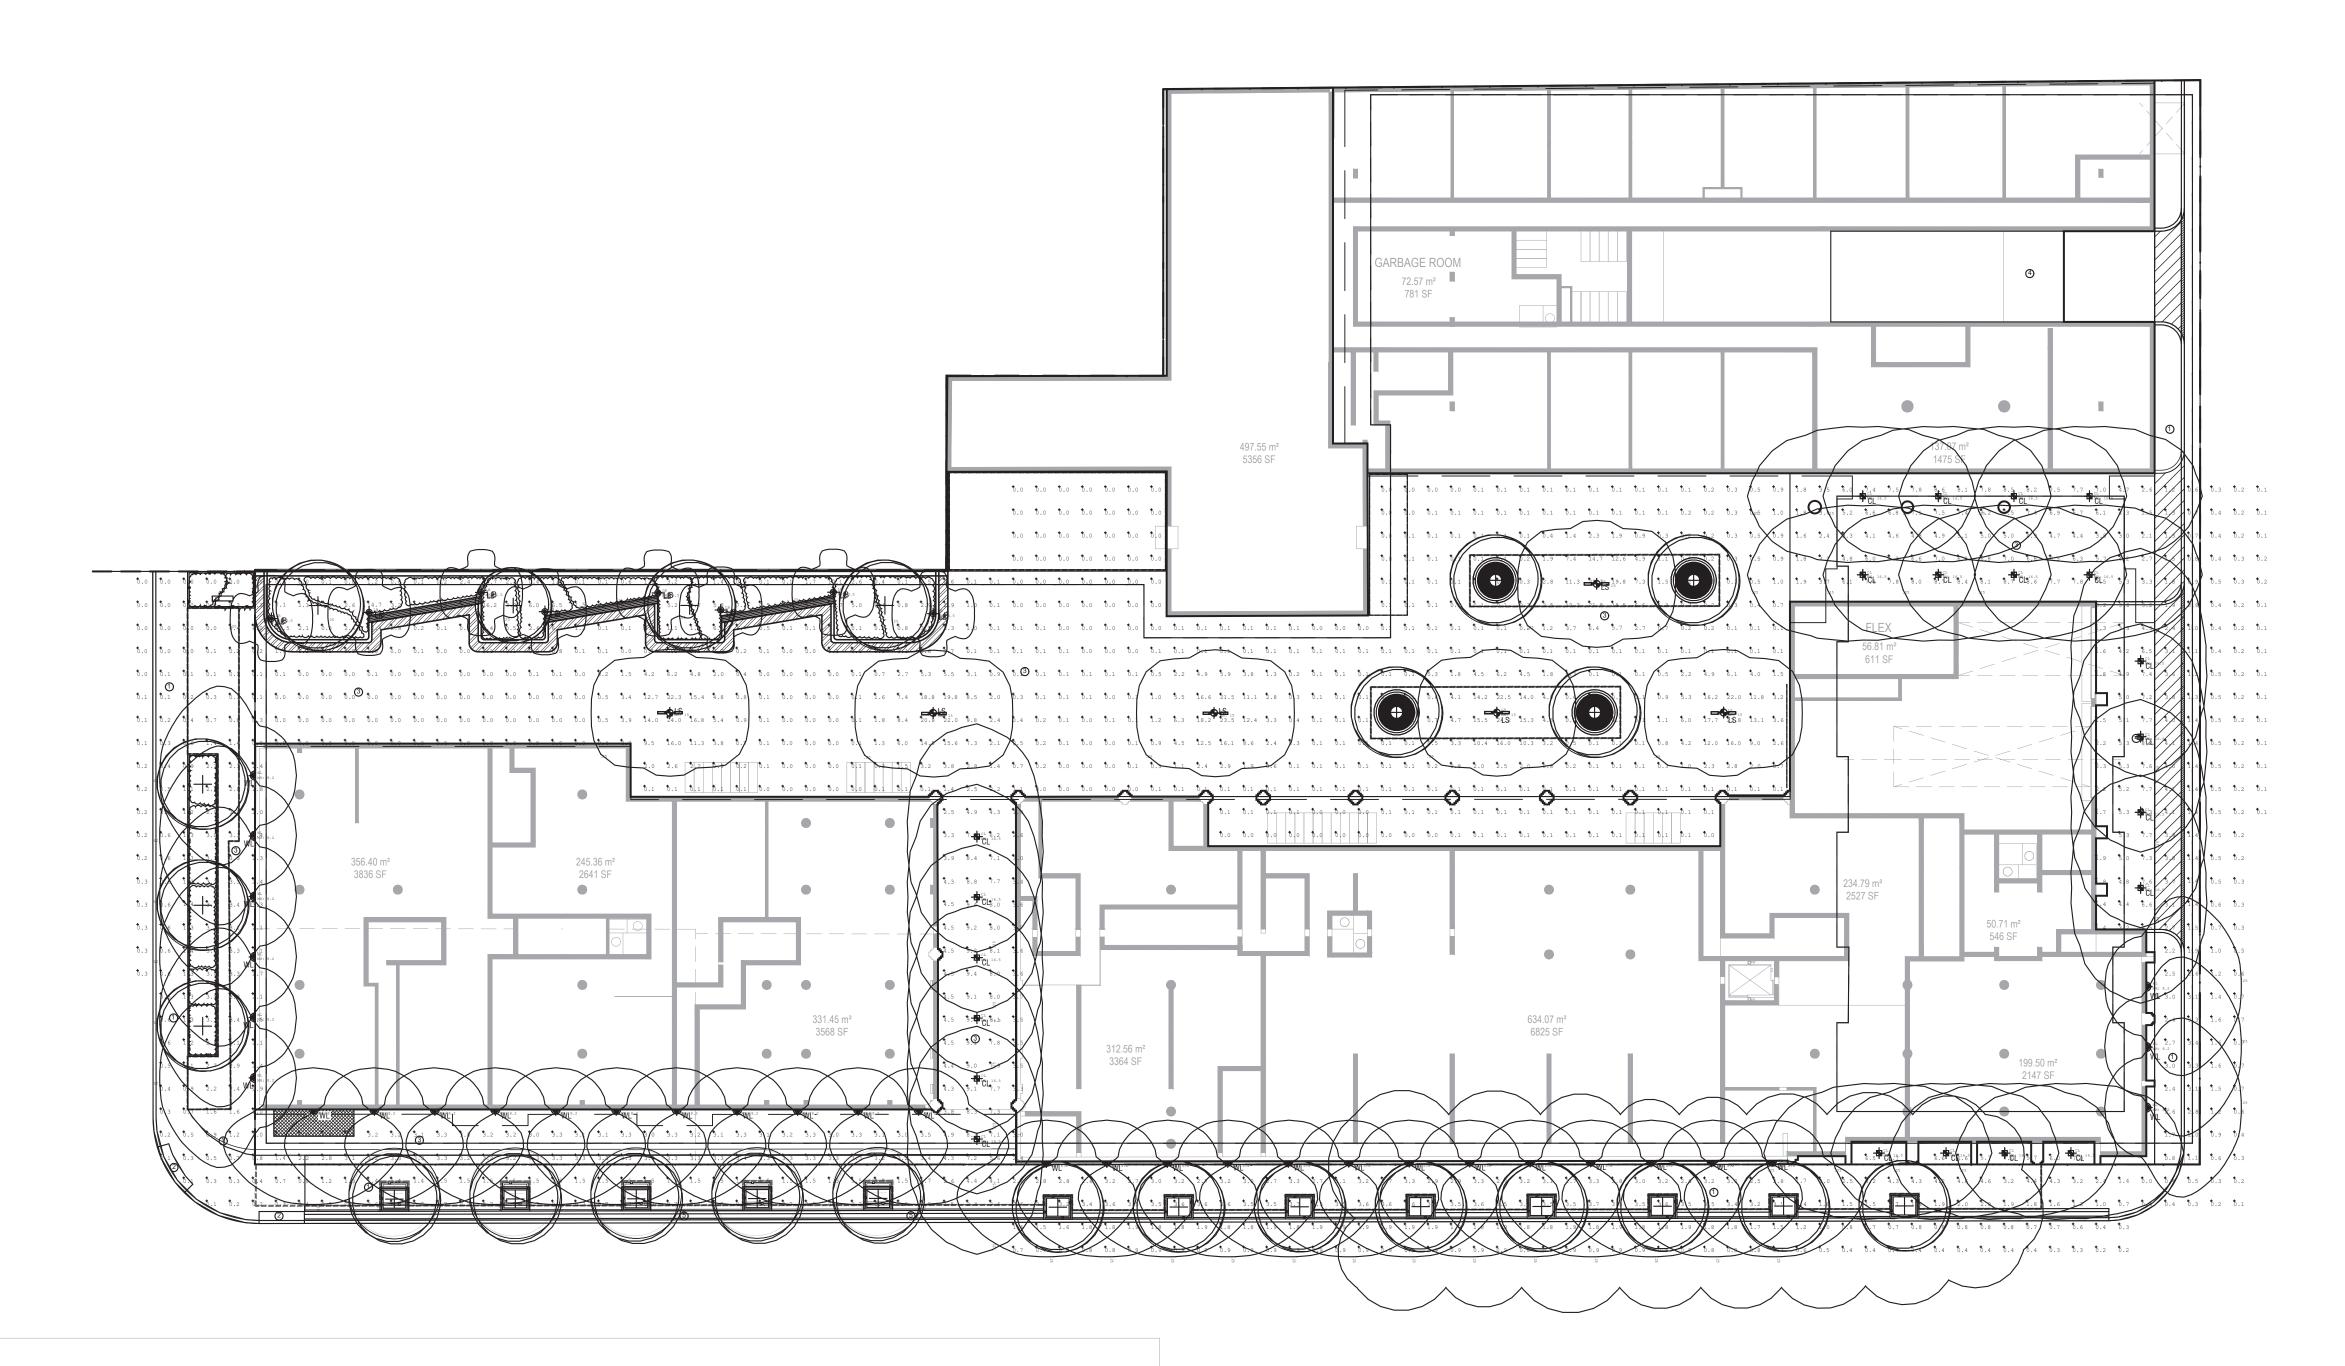



Architect - Sweeny & Co.
Civil Eng - R. V. Anderson Associates
Planner - Bousfields Inc.
Mech Eng Interior -

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REV DATE DESCRIPTION

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Photometric Plan

DRAWN BY: RH
CHECKED BY: JVV
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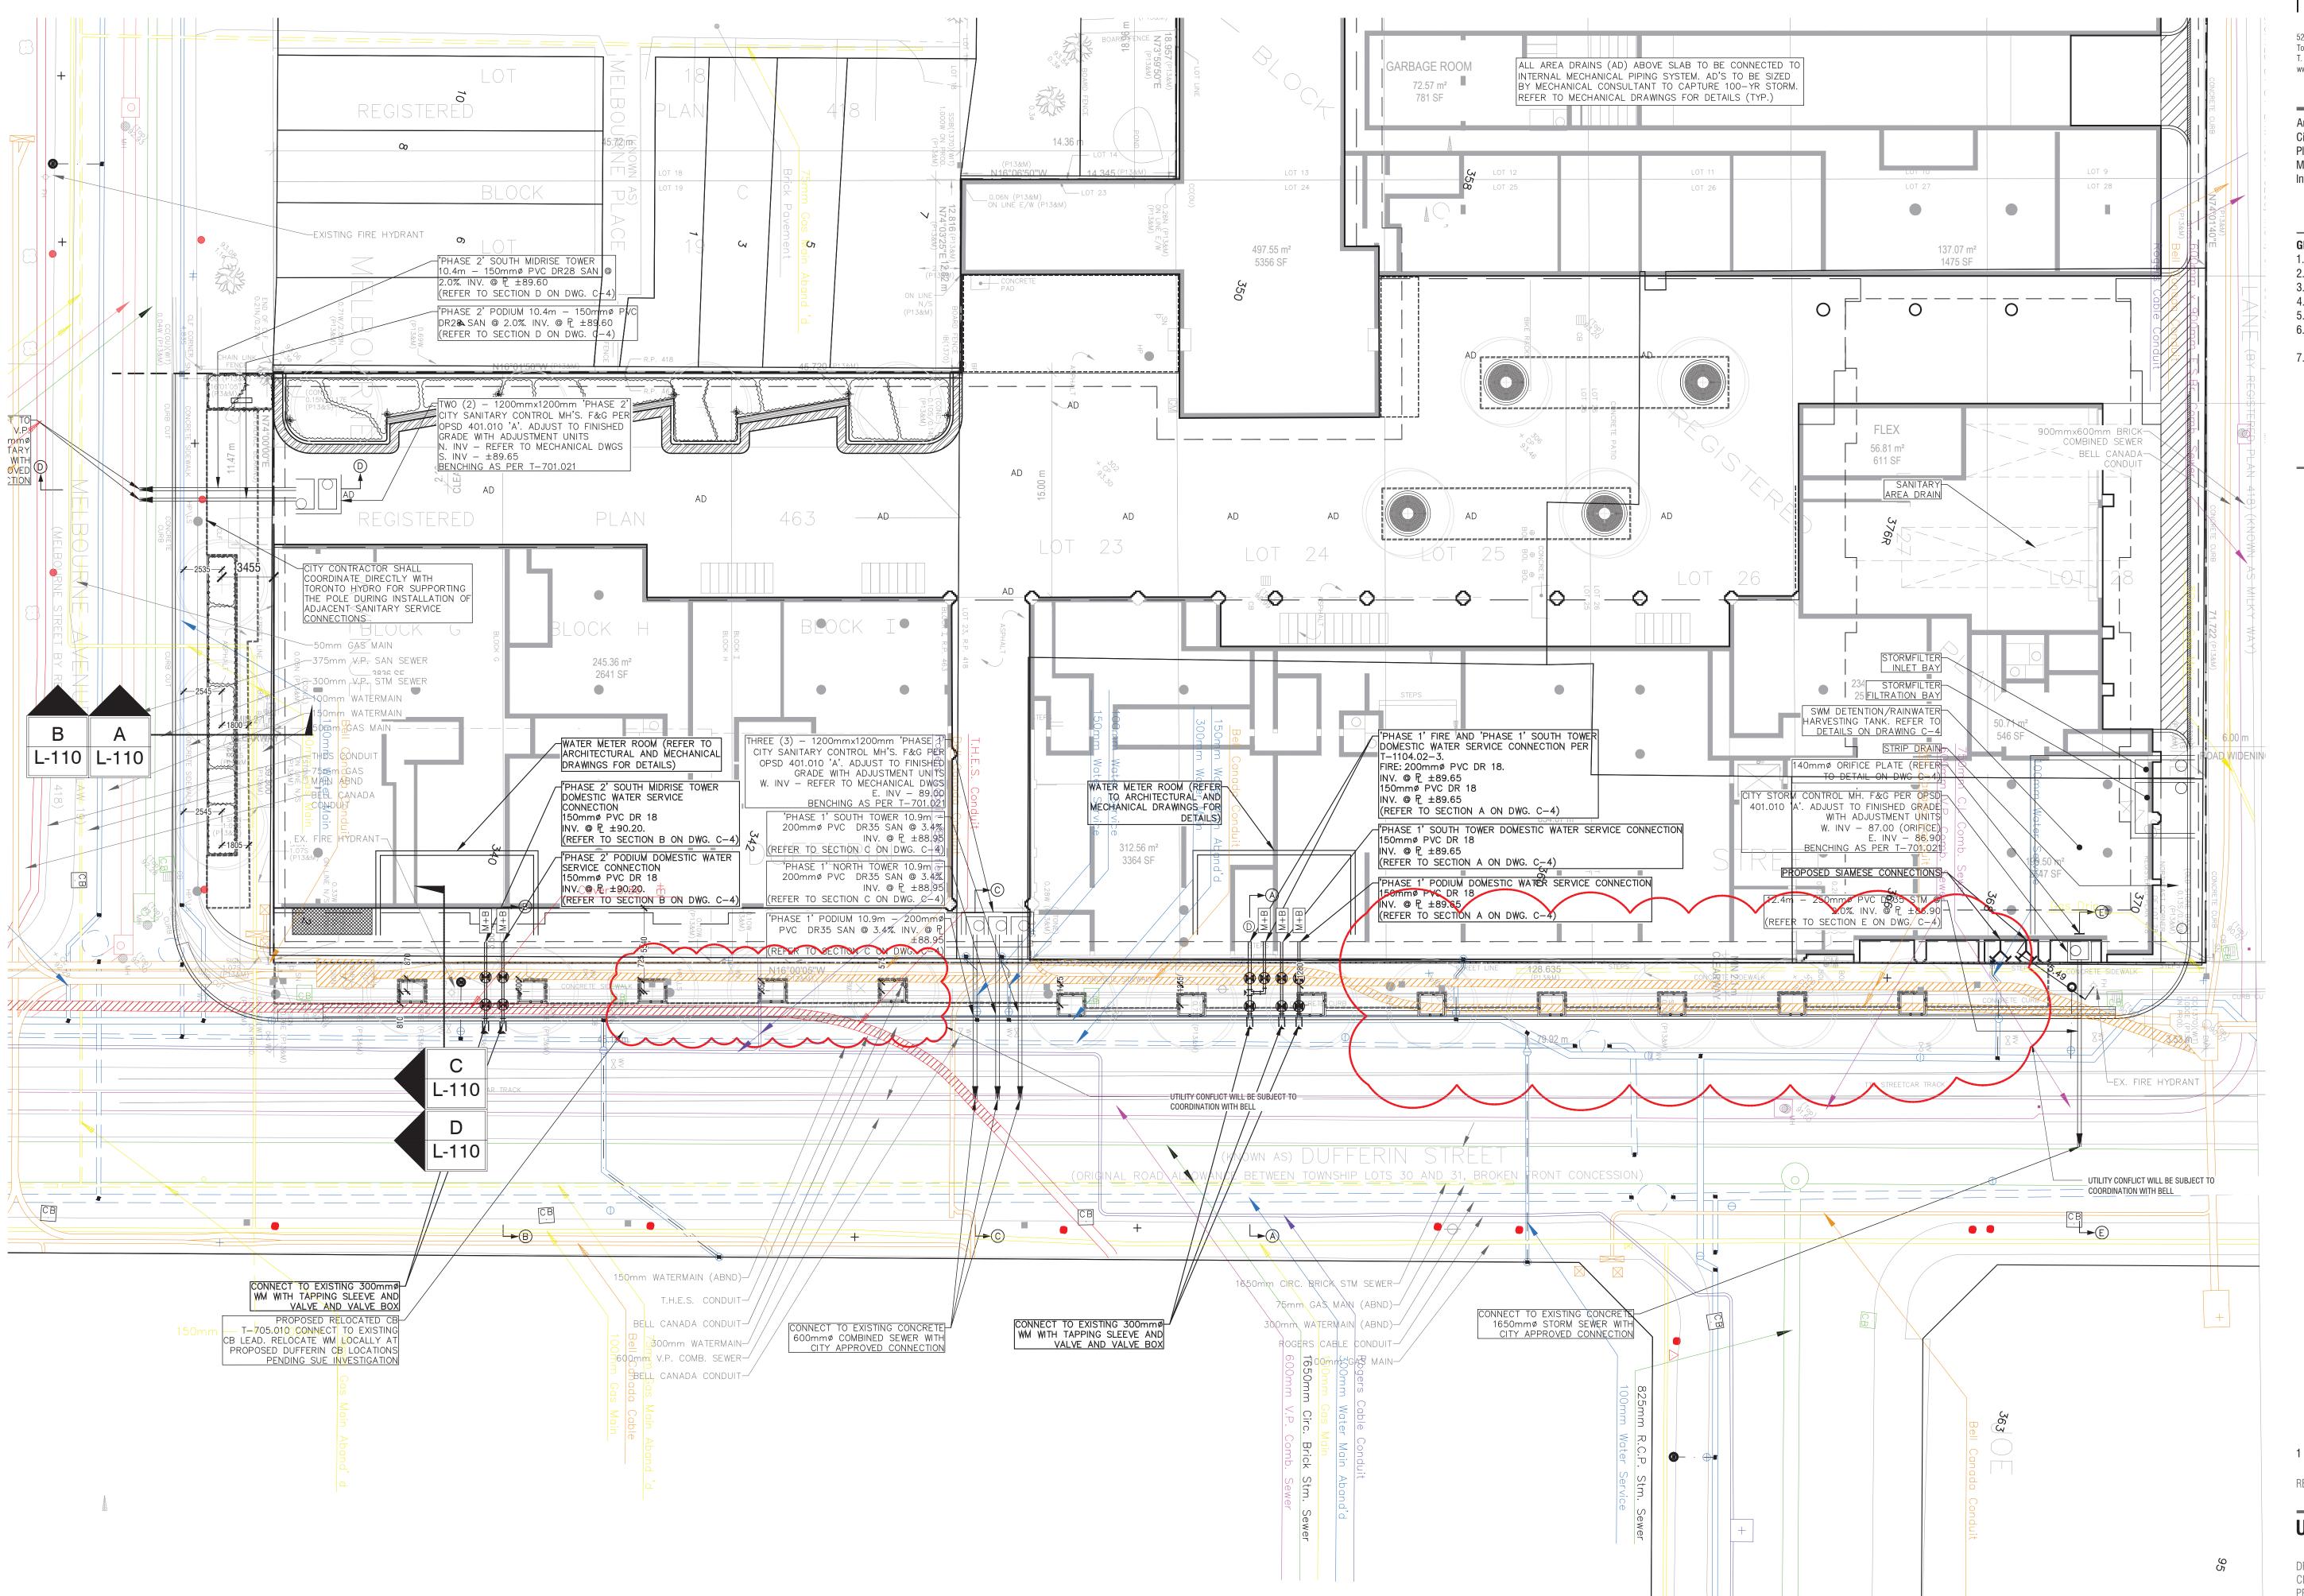







LAD-519 04.05.2022

HULLMARK



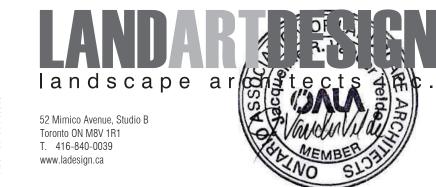

Architect - Sweeny & Co.
Civil Eng - R. V. Anderson Associates
Planner - Bousfields Inc.
Mech Eng Interior -

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Utility & Servicing Coordination Plan

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PRINT DATE: Jul.29.2022


L-10

INITIAL

Radiator TORONTO, ON

HULLMARK



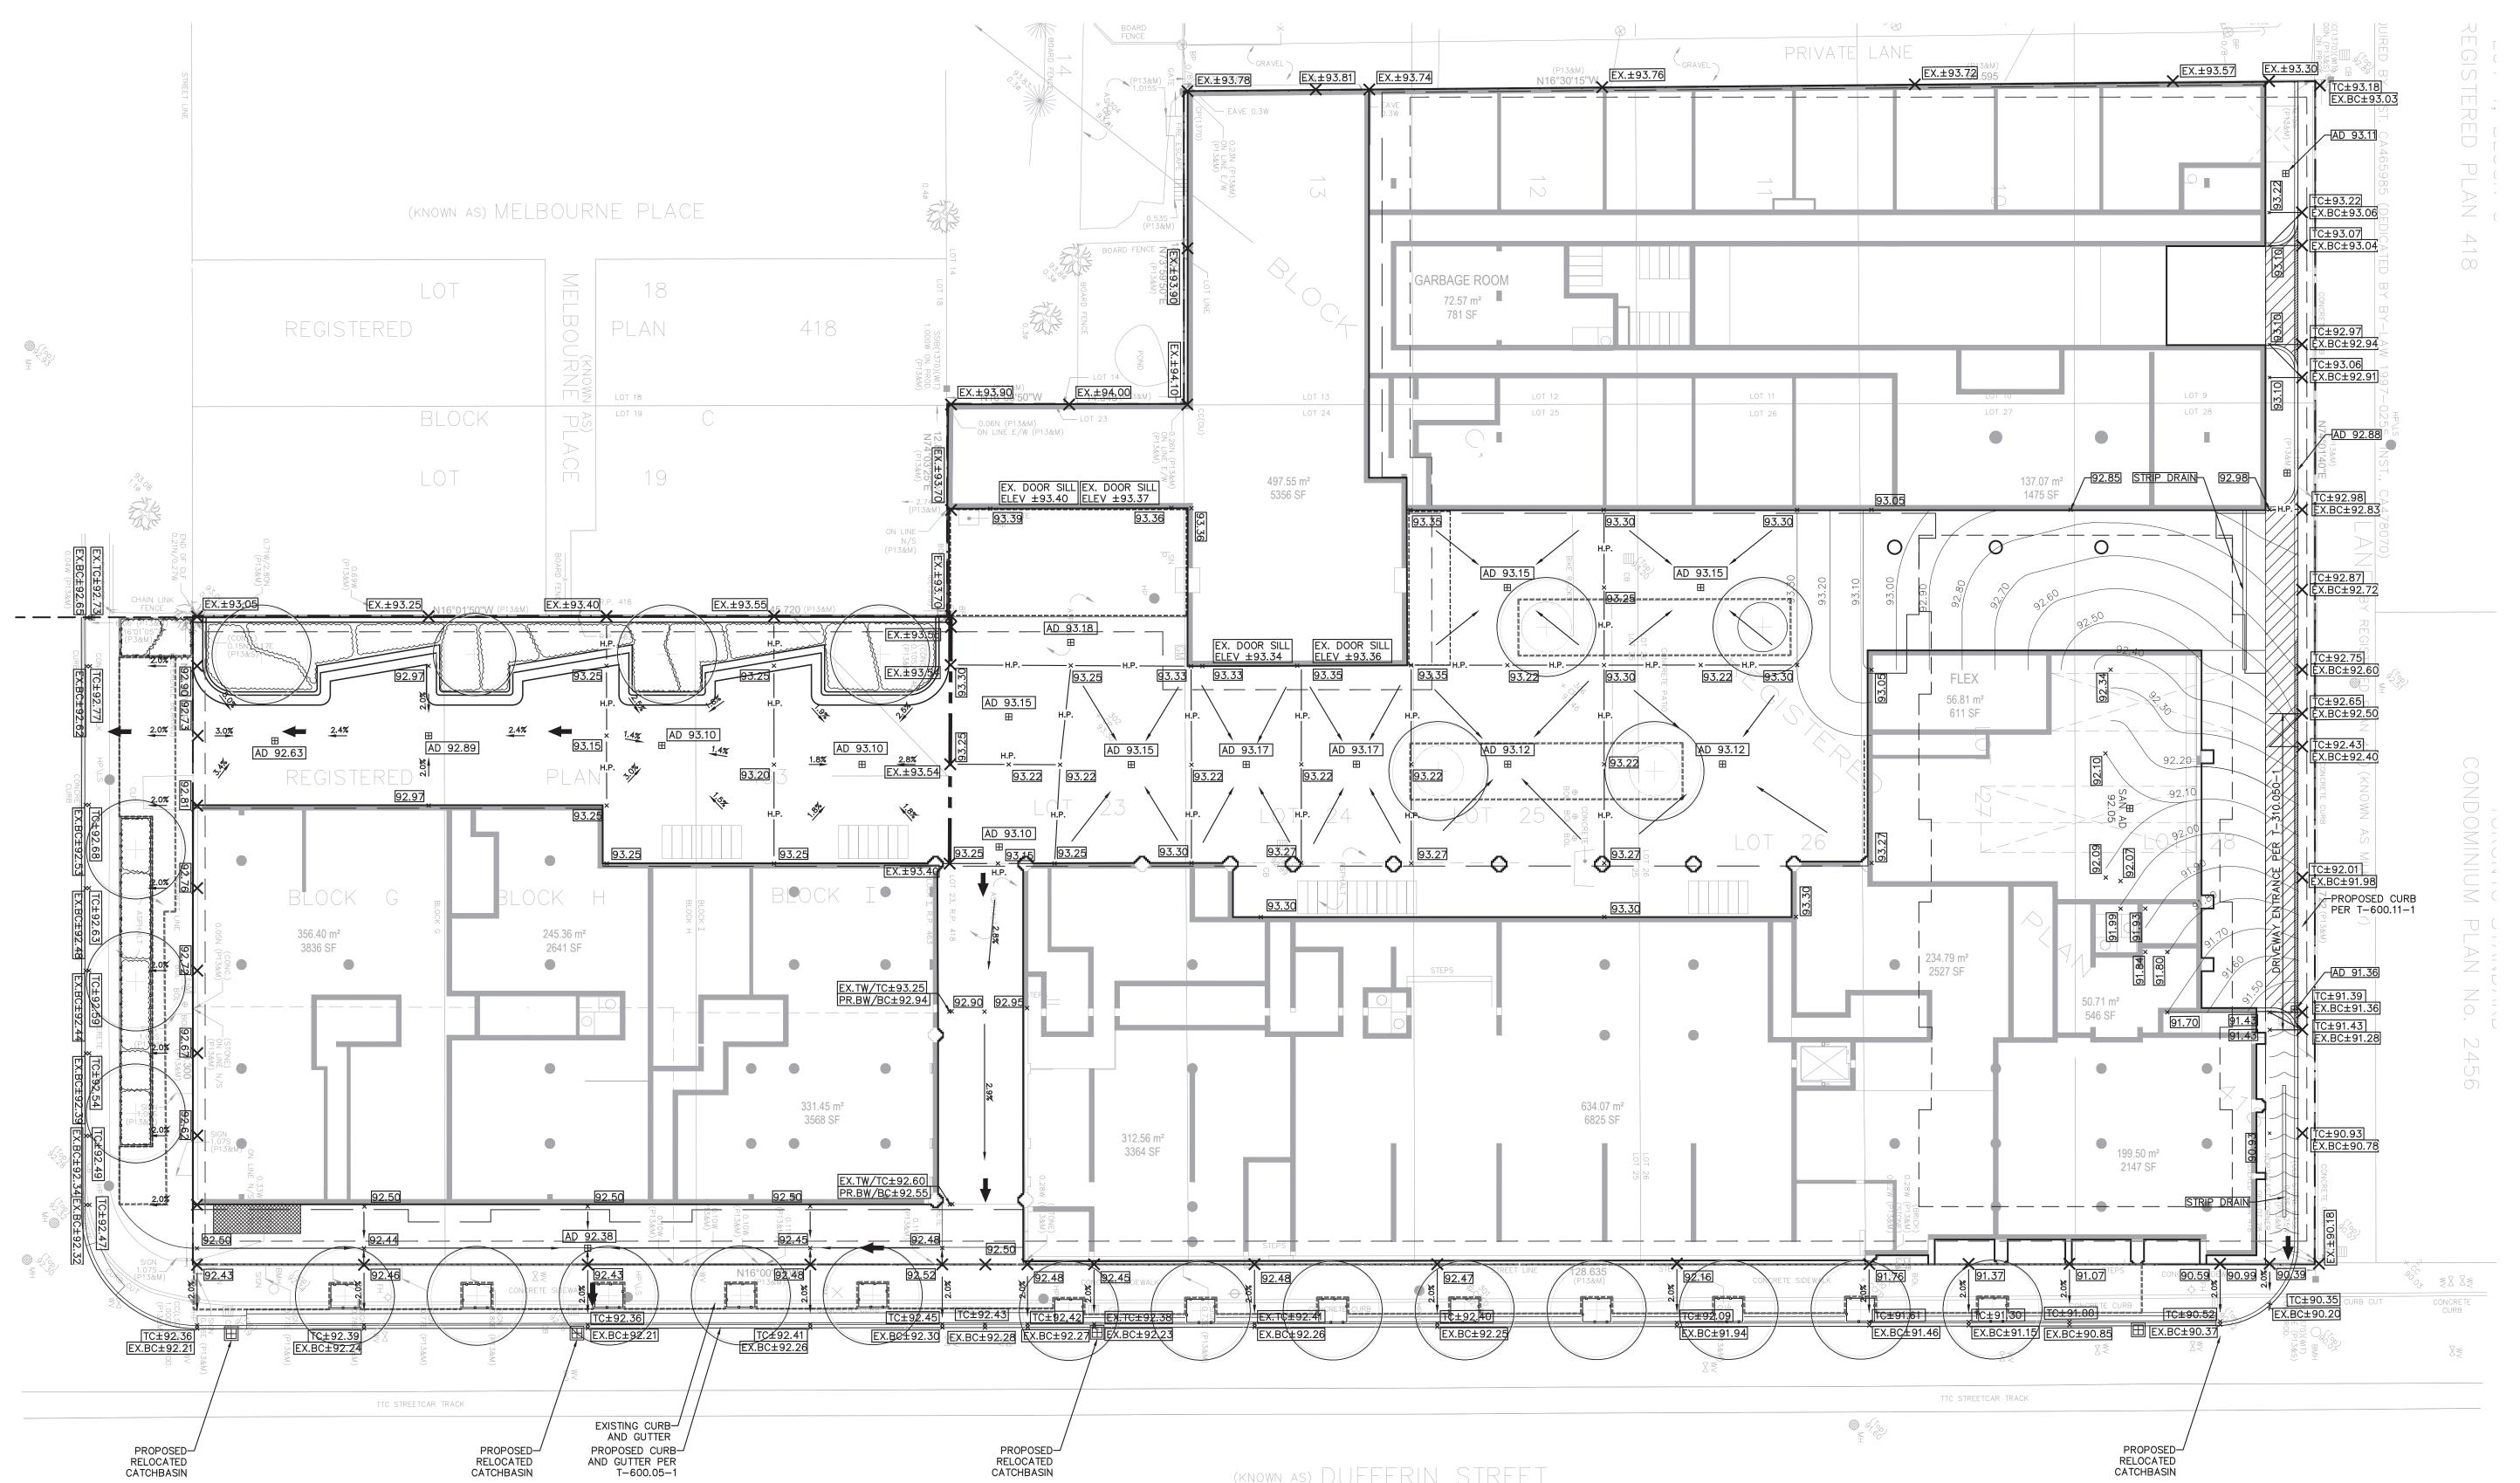

(known as) DUFFERIN STREET (ORIGINAL ROAD ALLOWANCE BETWEEN TOWNSHIP LOTS 30 AND 31, BROKEN FRONT CONCESSION)

 \ominus

landscape ar constep 52 Mimico Avenue, Studio B Toronto ON M8V 1R1 T. 416-840-0039 www.ladesign.ca

Architect - Sweeny & Co. Civil Eng - R. V. Anderson Associates Planner - Bousfields Inc. Mech Eng -Interior -

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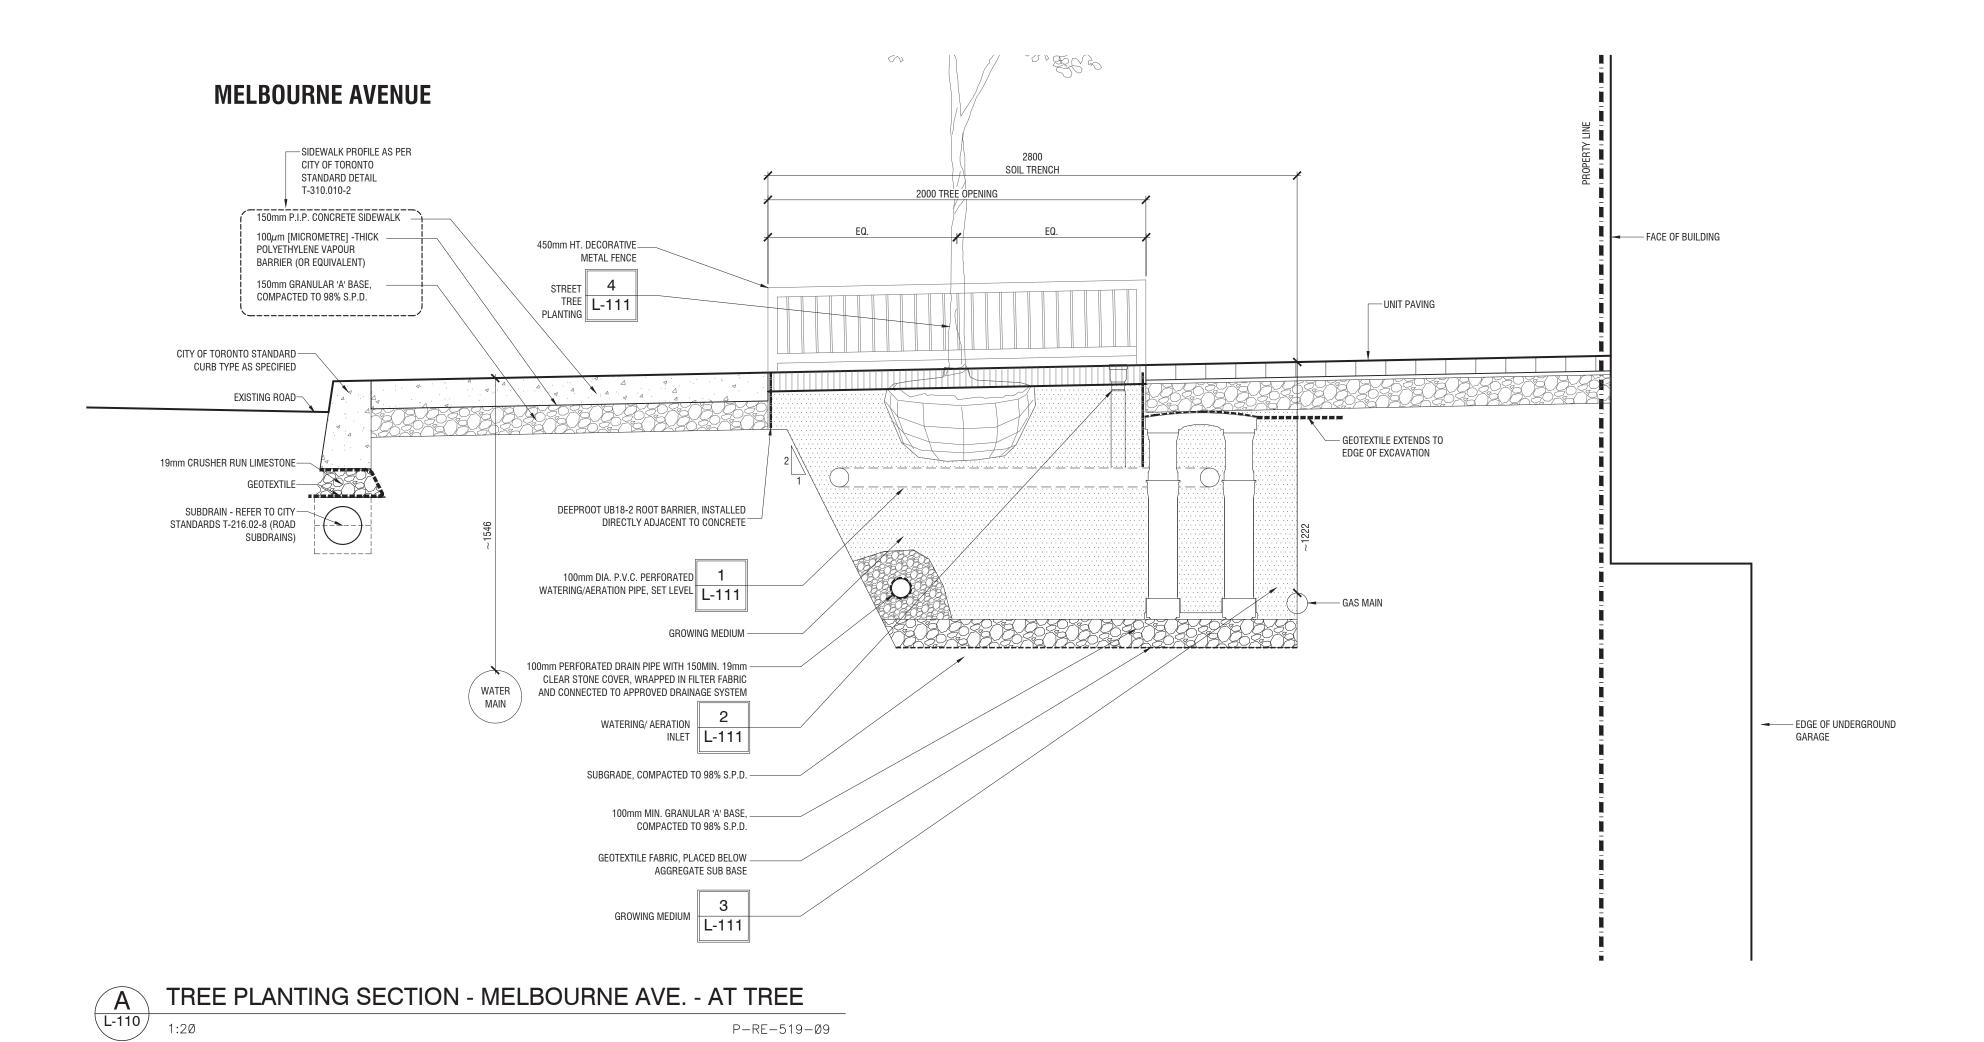
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PRINT DATE: Jul.29.2022

Radiator TORONTO, ON

1:200


Grading Plan

HULLMARK LAD-519 04.05.2022




PLANTING L-111 450mm HT. DECORATIVE METAL FENCE — SOIL TRENCH


P-RE-519-Ø9

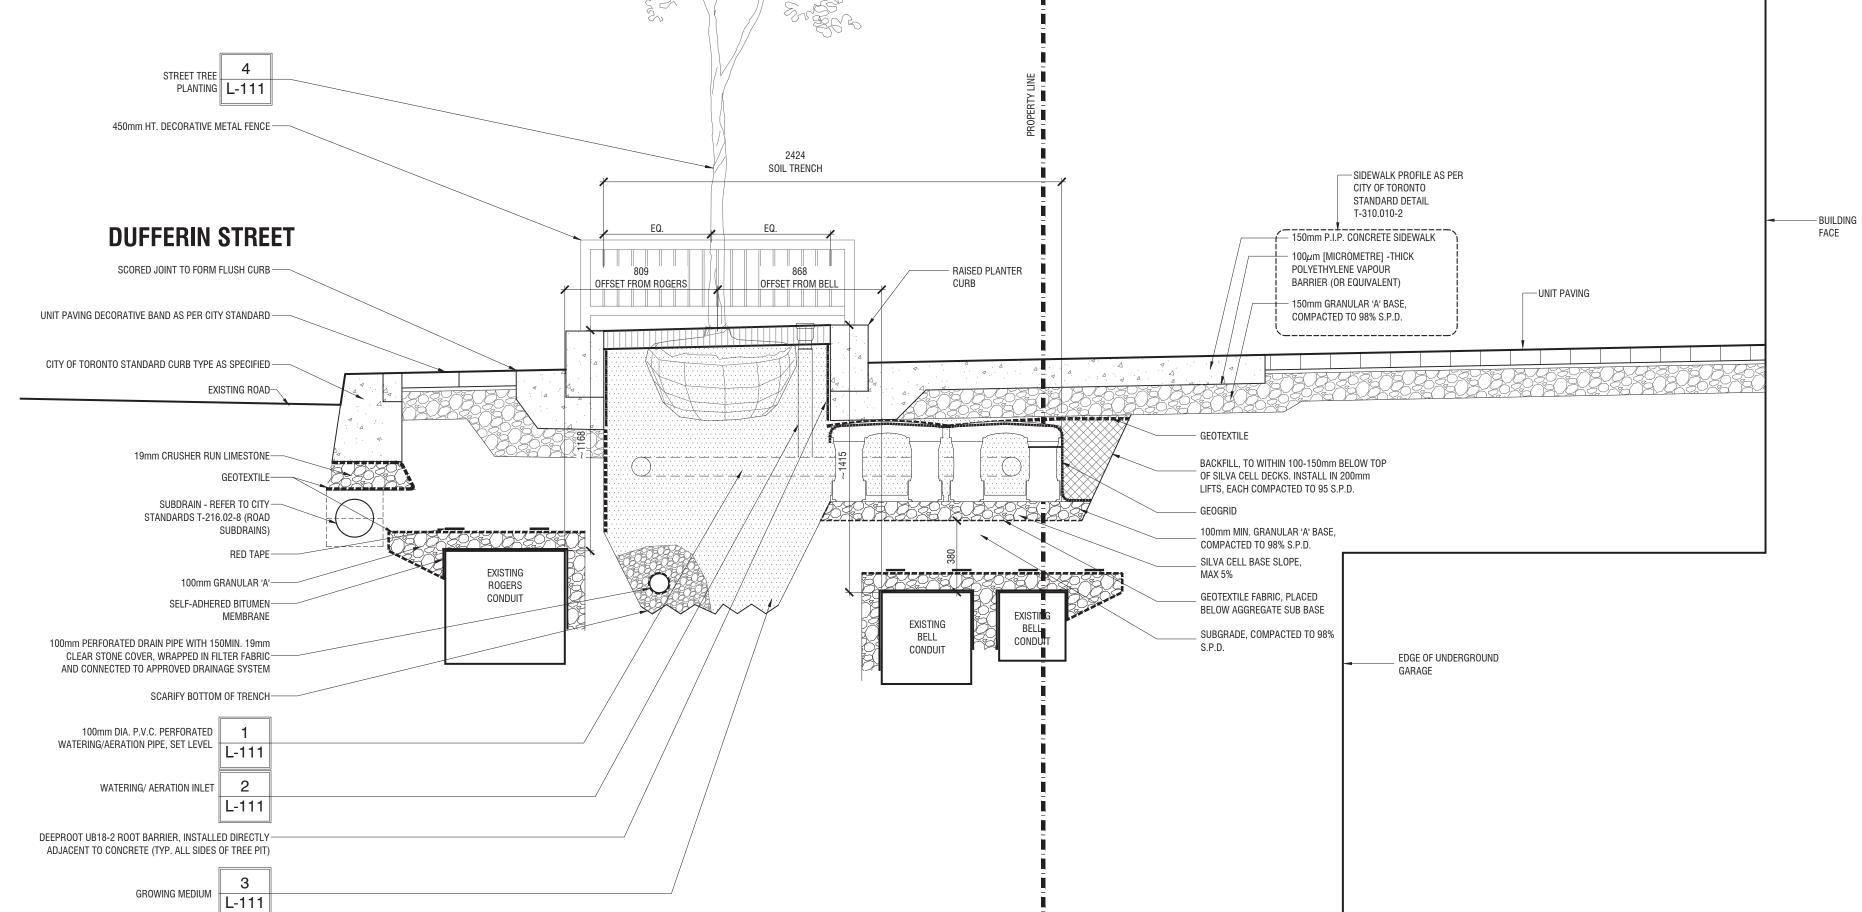

TREE PLANTING SECTION - DUFFERIN STREET - AT TREE P-RE-519-1Ø

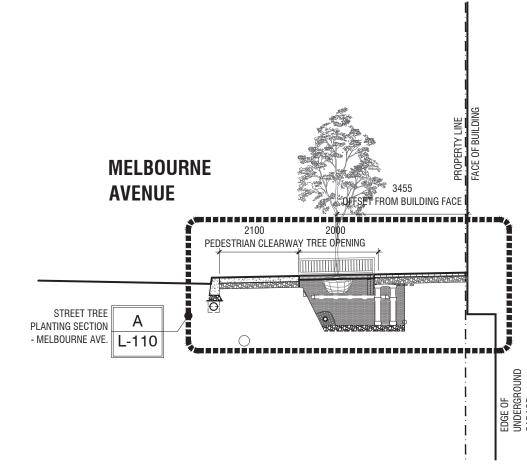

STREET TREE SETBACKS - MELBOURNE AVE. - AT TREE B L-110 P-RE-519-12

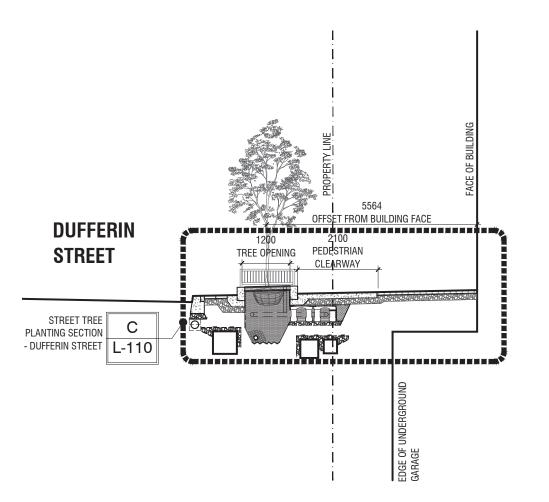

STREET TREE SETBACKS - DUFFERIN STREET - AT TREE

1:100

1:100

P-RE-519-11

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Architect - Sweeny & Co. Civil Eng - R. V. Anderson Associates Planner - Bousfields Inc. Mech Eng -Interior -

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proceeding 7. Drawings and specifications are the property of the Landscape Architect, and must be returned upon completion of the work

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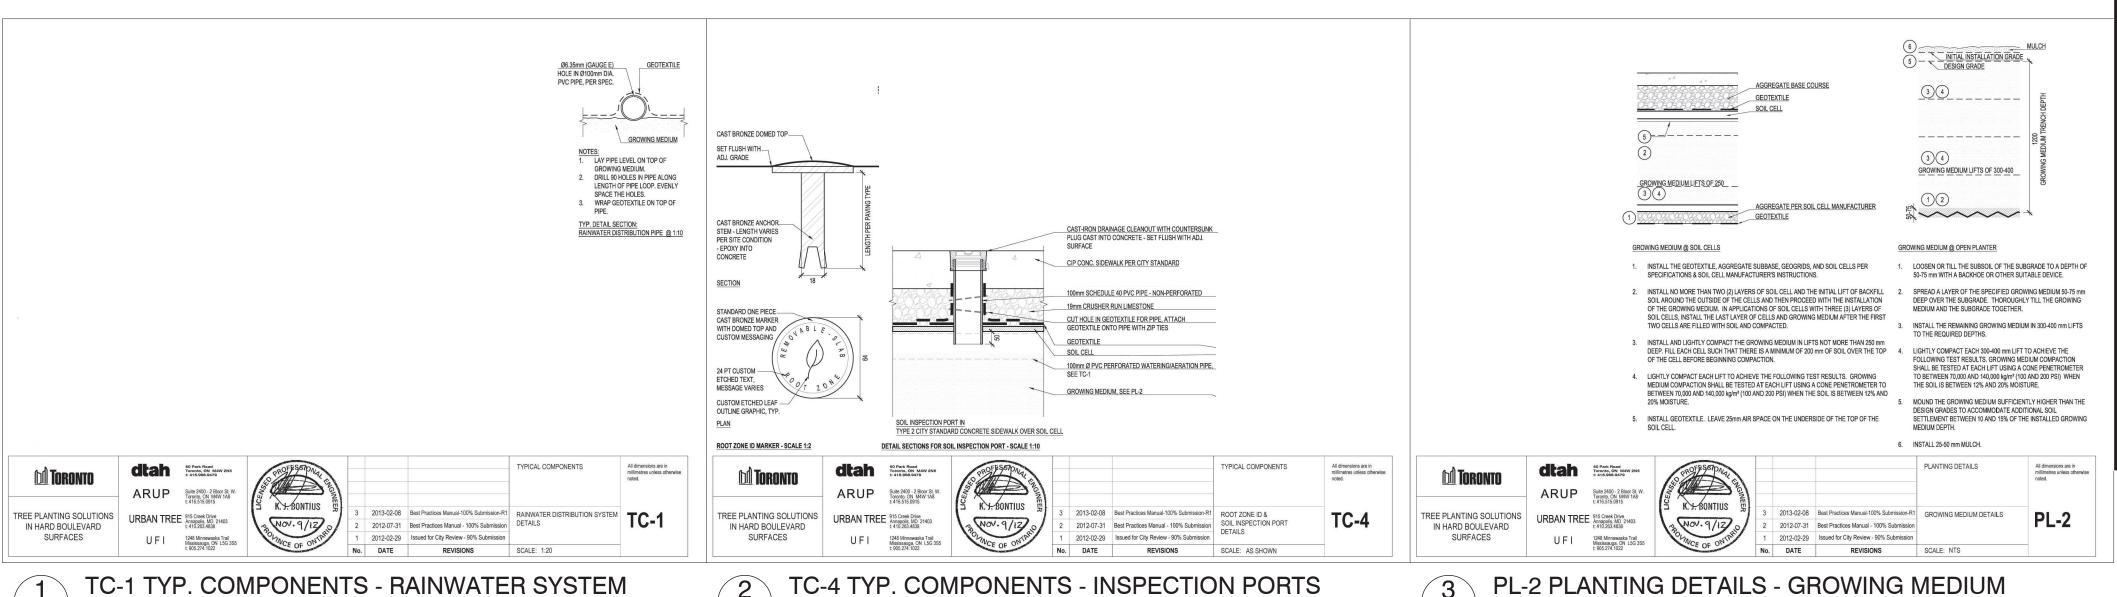
DESCRIPTION INITIAL

Street Tree Planting Sections

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CHECKED BY: JVV
PRINT DATE: Jul.29.2022








320101.20-41

L-111

320101.20-44

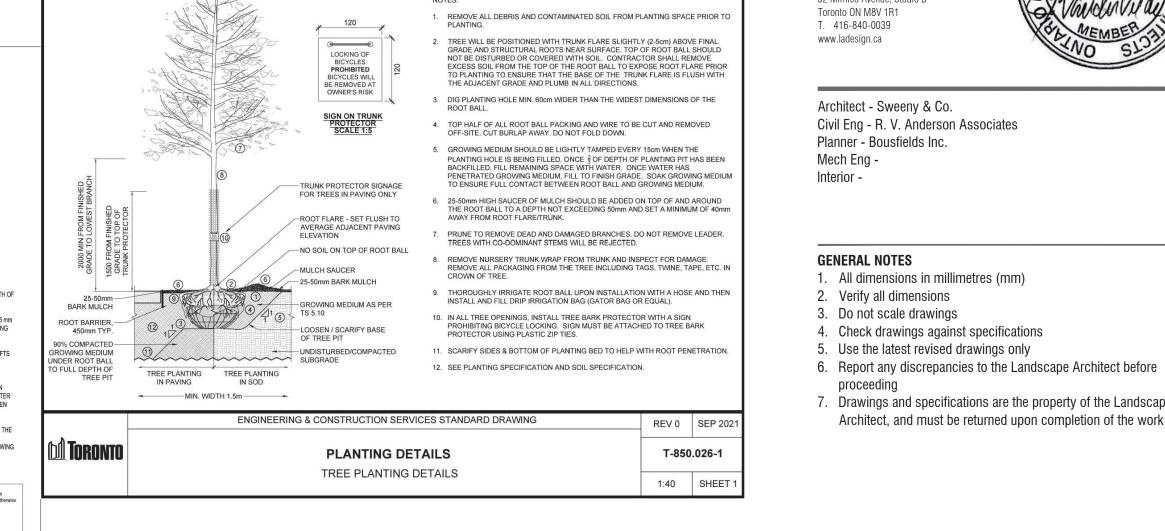

TREE PLANTING DETAILS

L-111

320101.20-62

320101.11-01

52 Mimico Avenue, Studio B Toronto ON M8V 1R1

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Planner - Bousfields Inc.

Civil Eng - R. V. Anderson Associates

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Mech Eng -

GENERAL NOTES

proceeding

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Interior -

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REV DATE DESCRIPTION


Toronto Standard Details - Tree Planting

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CHECKED BY: JVV
PRINT DATE: Jul.29.2022


L-111


HULLMARK


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2 L3 AMENITY TERRACE
1:100 P-RE-519-22
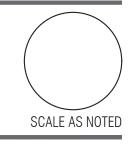
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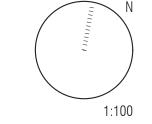
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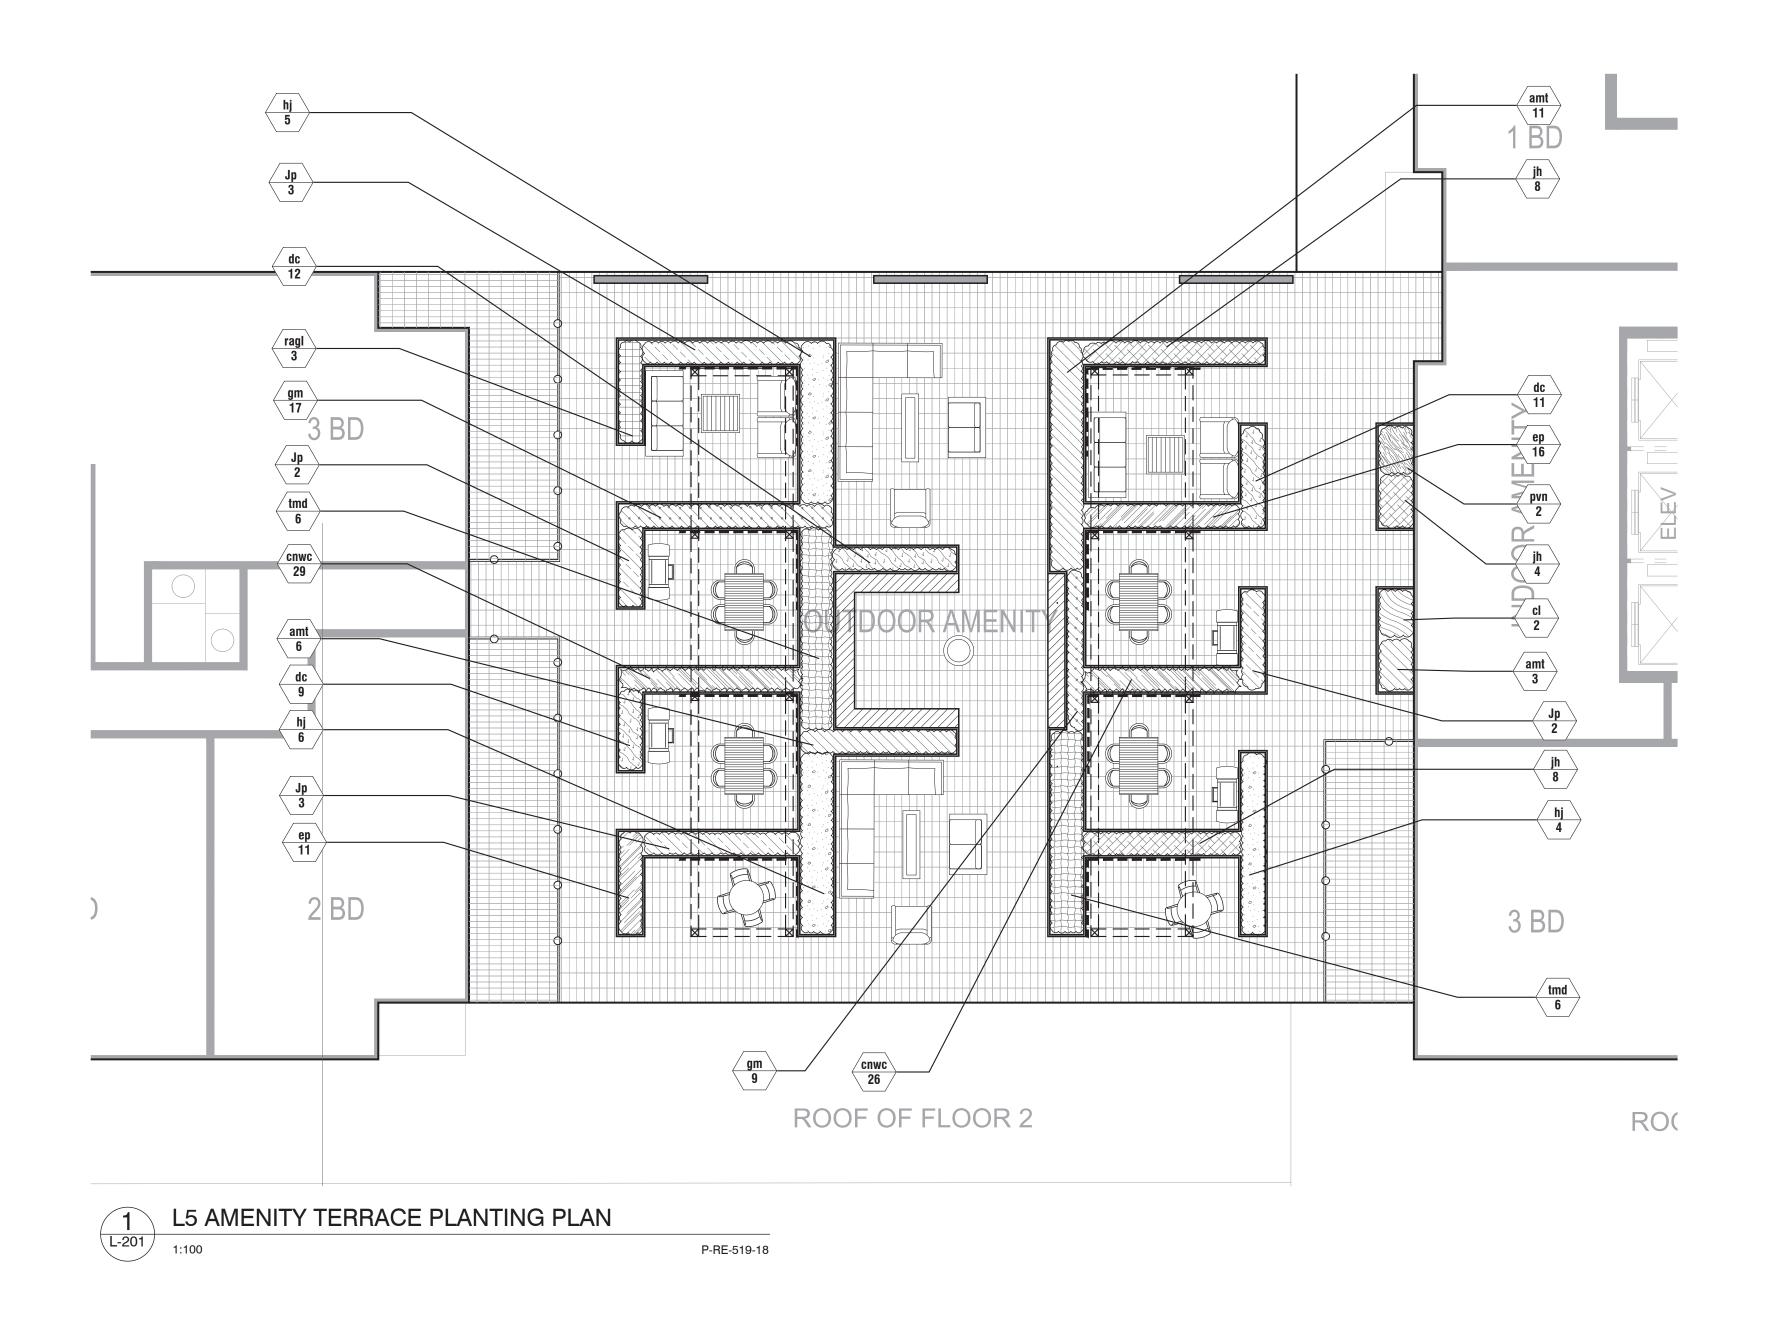
INITIAL


Amenity Terrace Landscape Plan

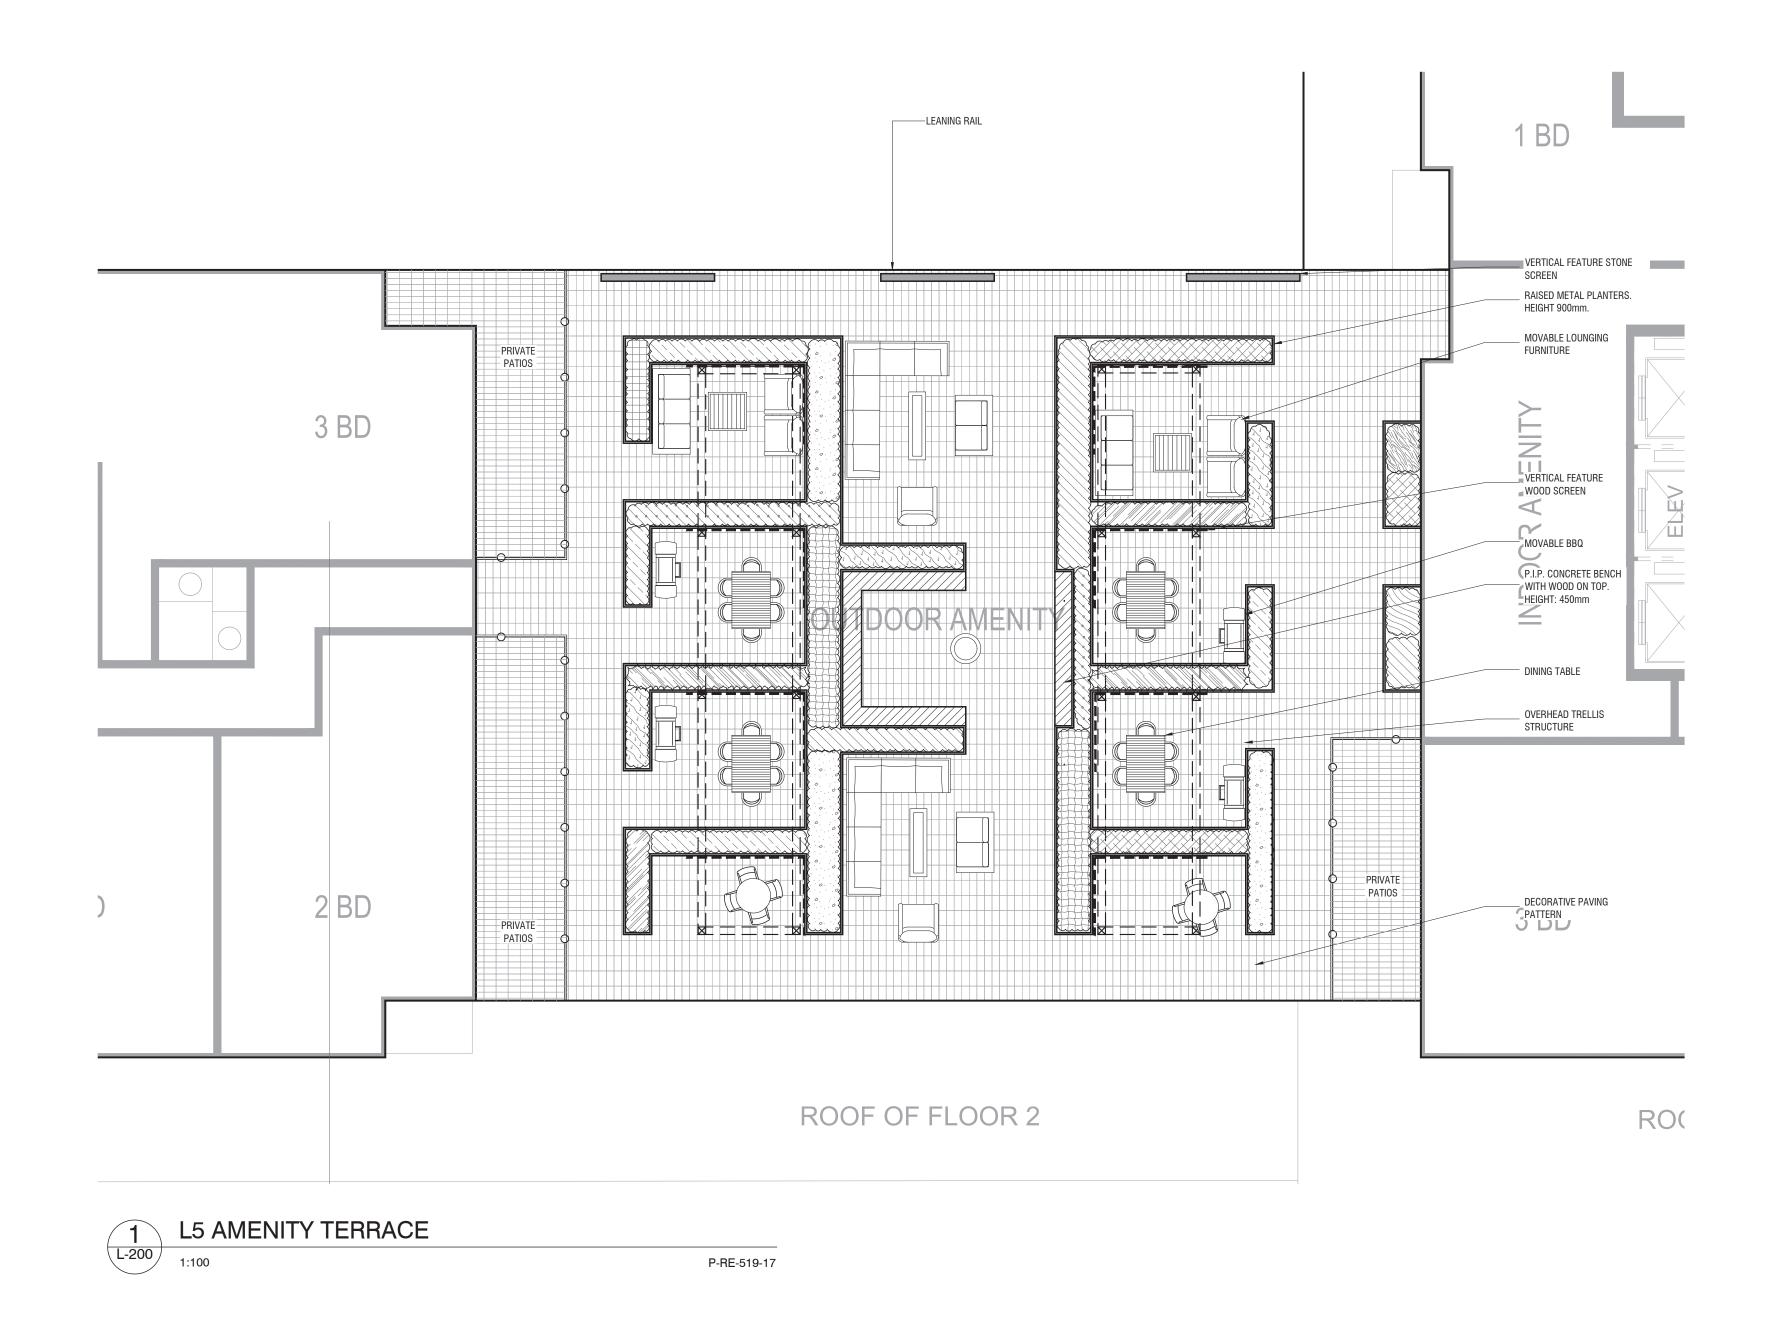
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PRINT DATE: Jul.29.2022

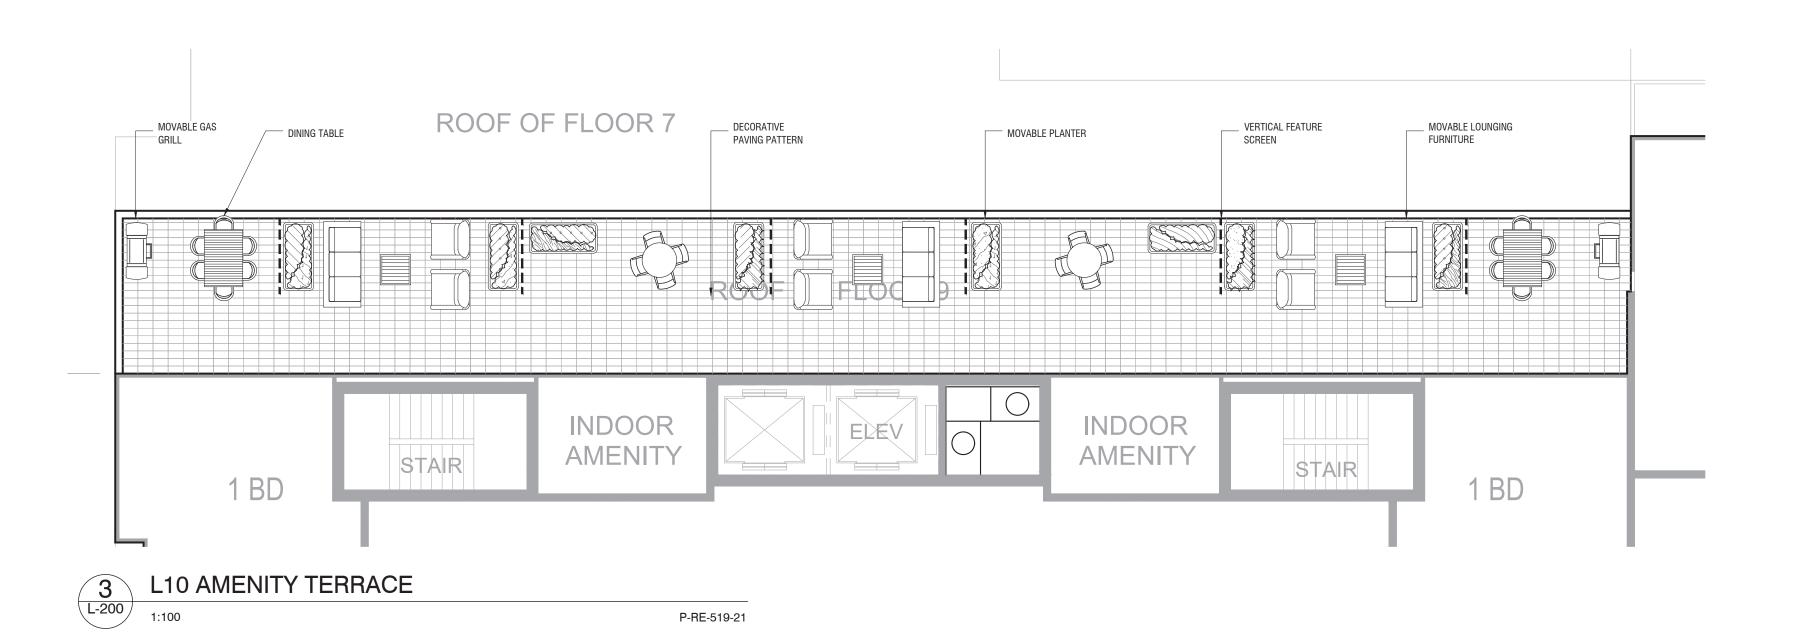Radiator TORONTO, ON HULLMARK

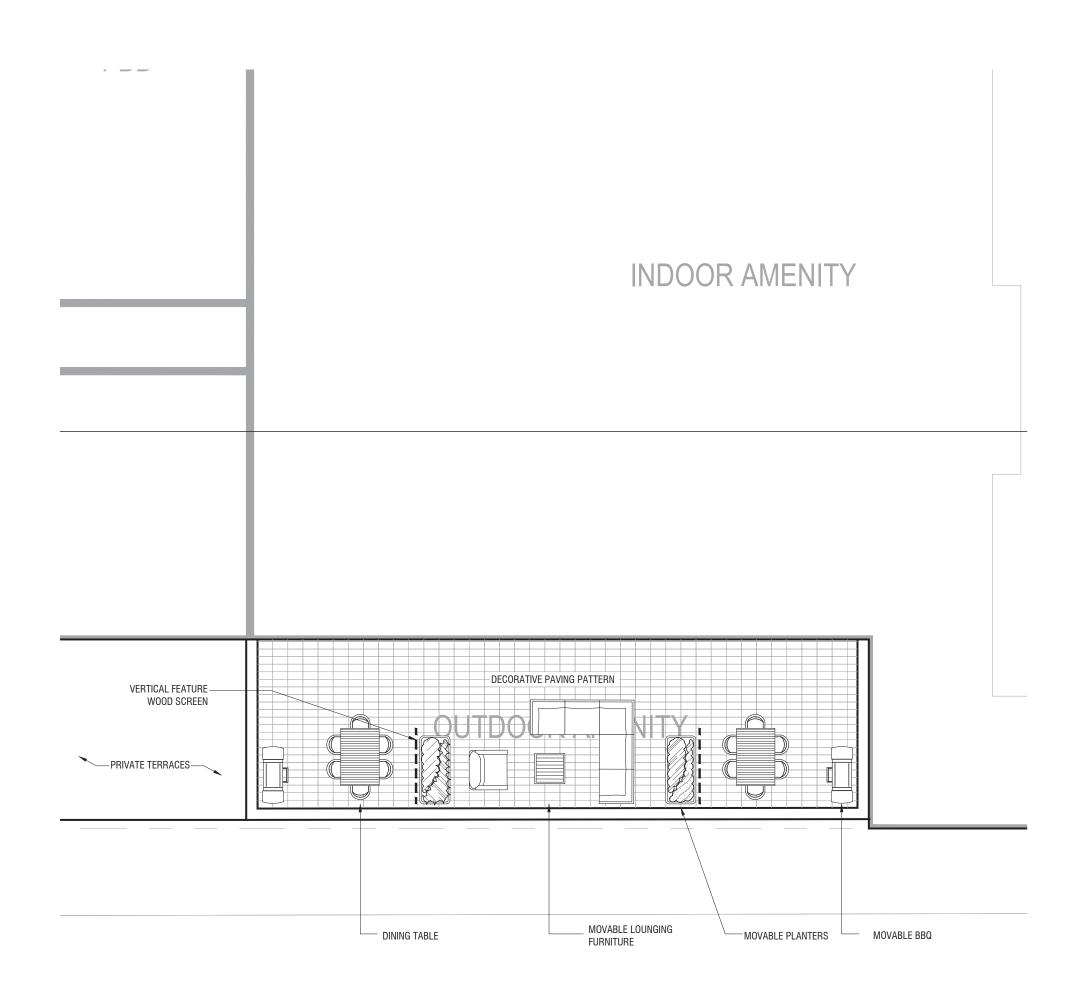



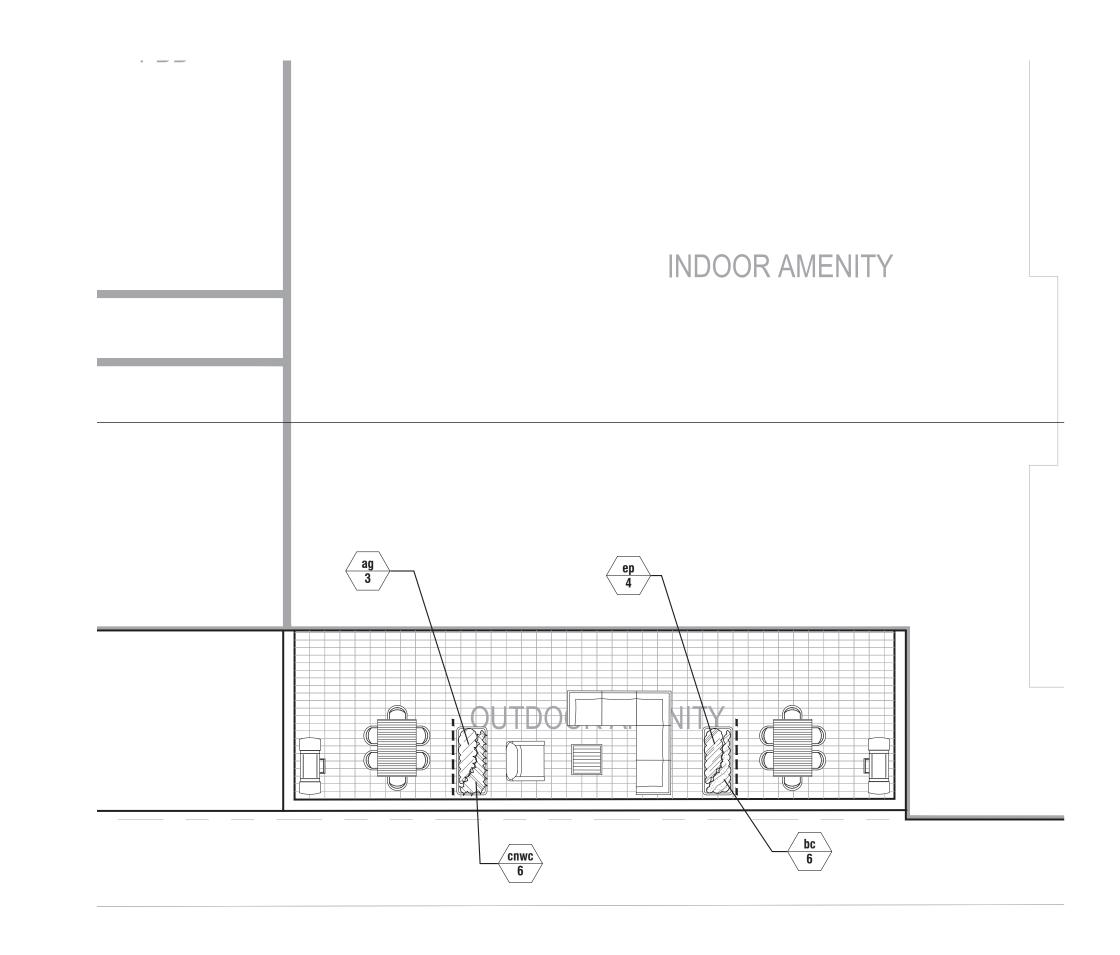

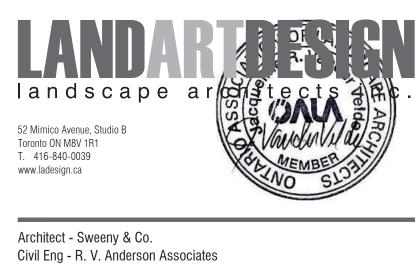


Planner - Bousfields Inc. Mech Eng -Interior -

GENERAL NOTES


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gm



P-RE-519-19

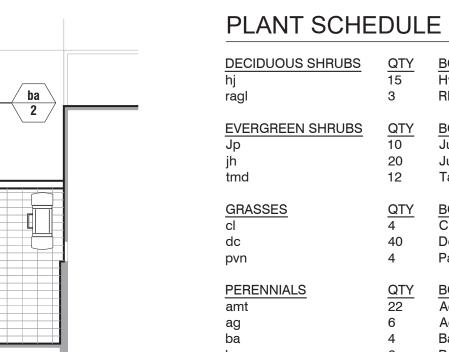2 L3 AMENITY TERRACE PLANTING PLAN
1:100


400mm 450mm 800mm
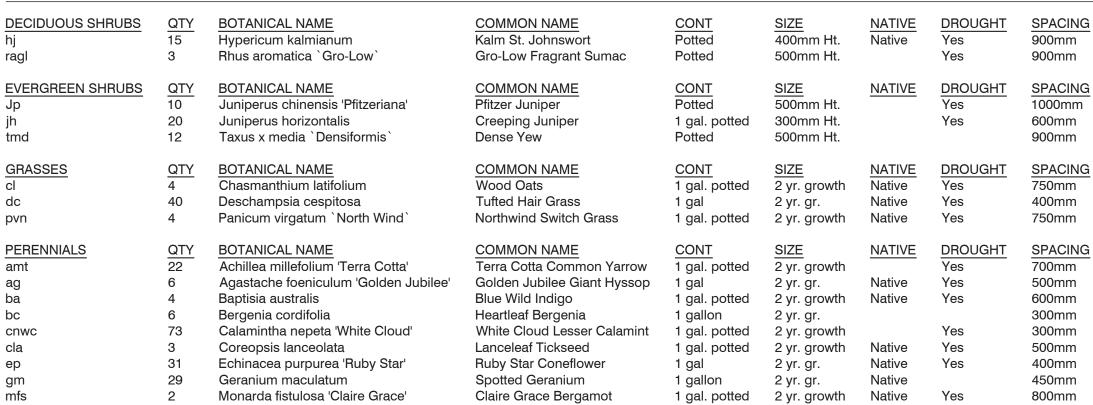
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REV DATE DESCRIPTION

Amenity Terrace Landscape Plan


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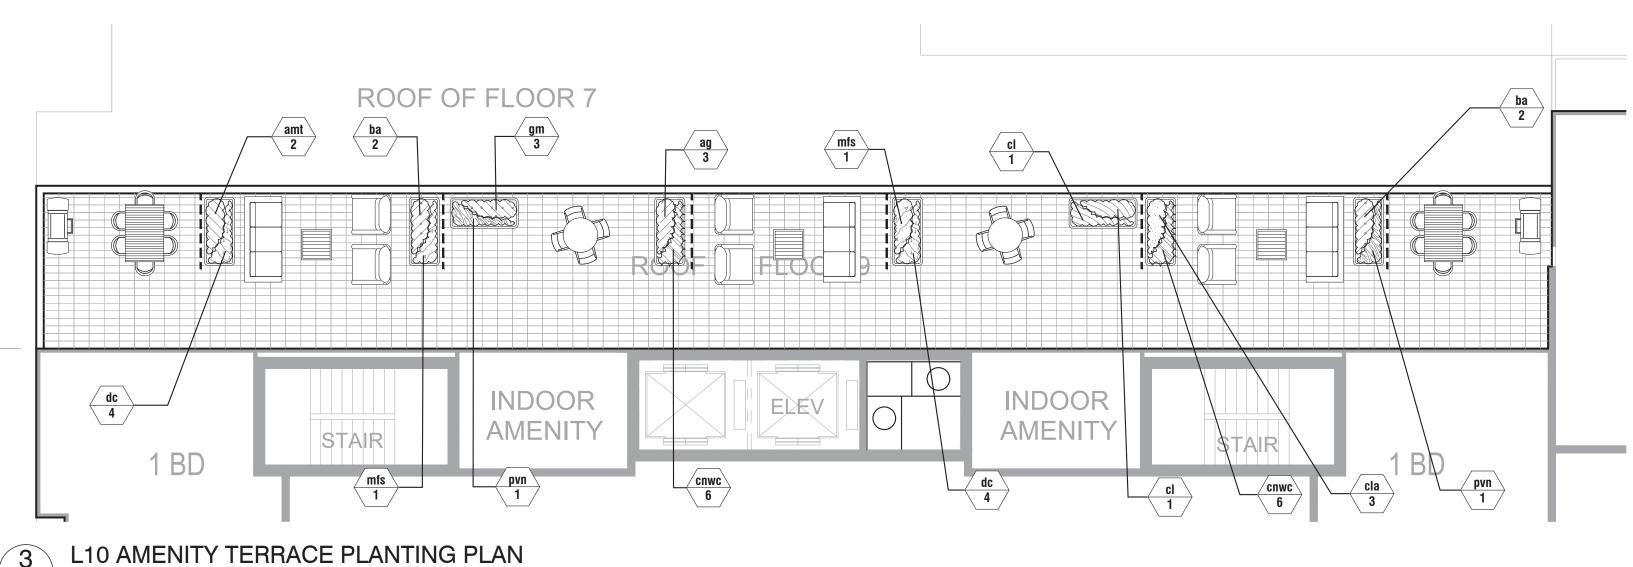


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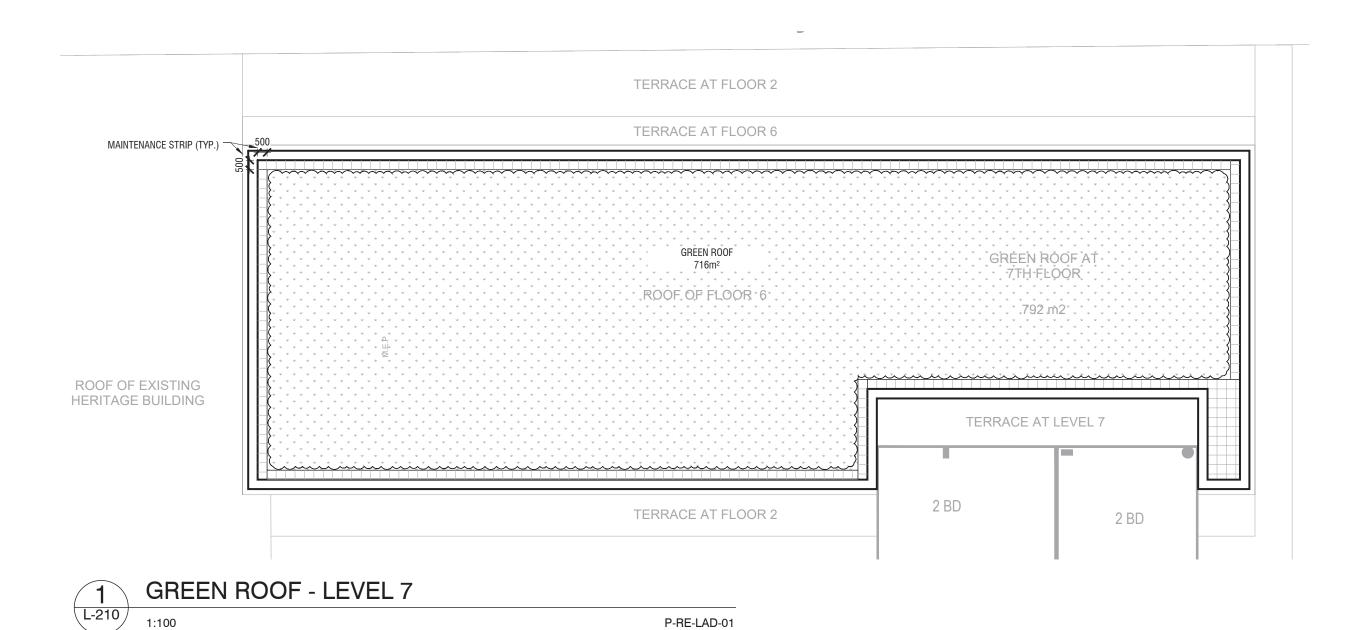


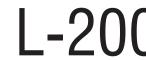
LAD-519 04.05.2022



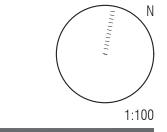

P-RE-519-20



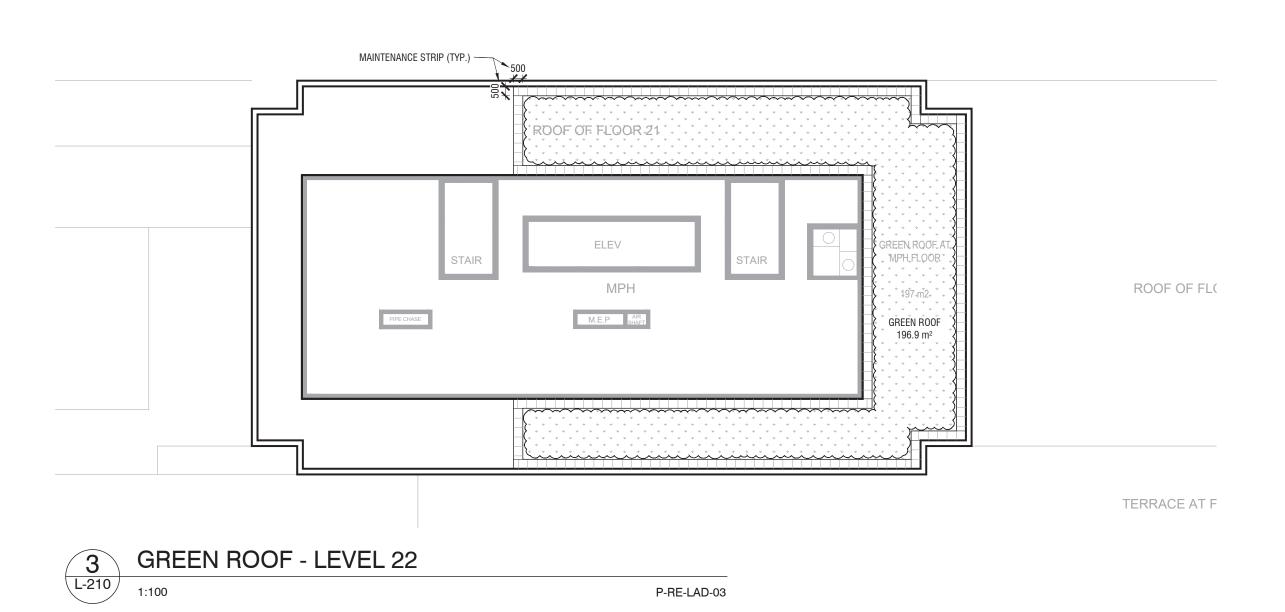


Green Roof Statistics


		Duanaaad		
		Proposed		
Gross Floor Area, as defined in Green Roof Bylaw (m ²)				
Total Roof Area (m ²)		4,828.0		
Area of Residential Private Terraces (m ²)				
Rooftop Outdoor Amenity Space, if in a Residential Building (m ²)				
Area of Renewable Energy Devices (m ²)				
Tower (s)Roof Area with floor plate less than 750 m ²				
Total Available Roof Space (m ²)				
Green Roof Coverage Required				
Coverage of Available Roof Space (m ²) 1,898.4				
Coverage of Available Roof Space (%) 60%				





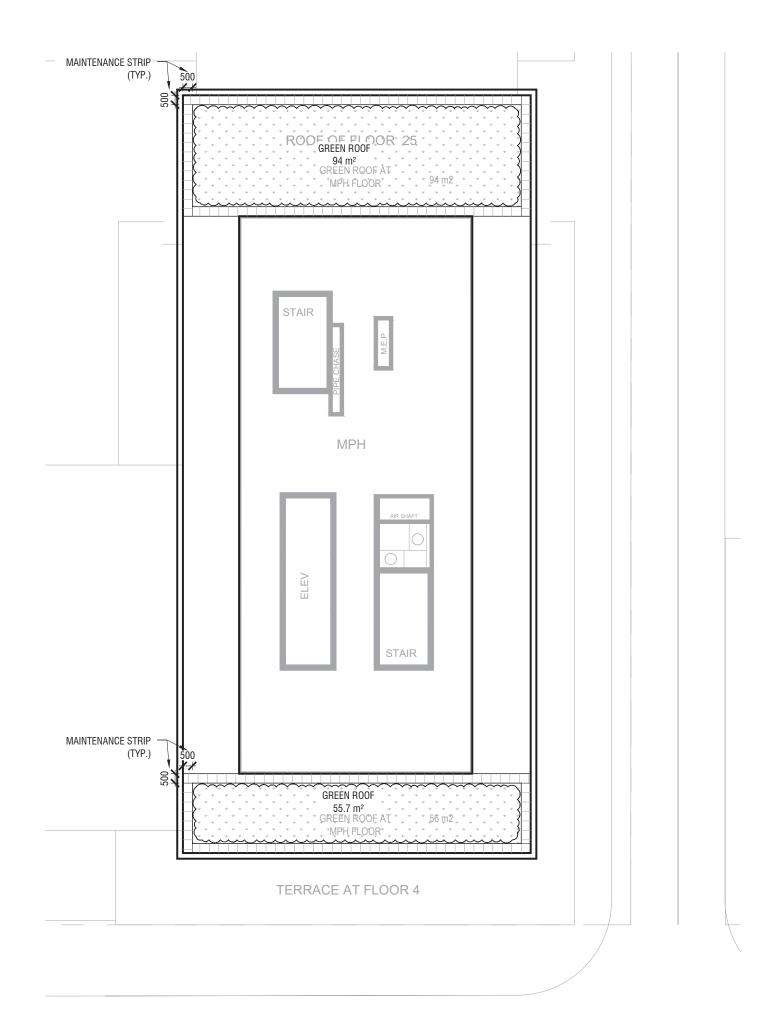



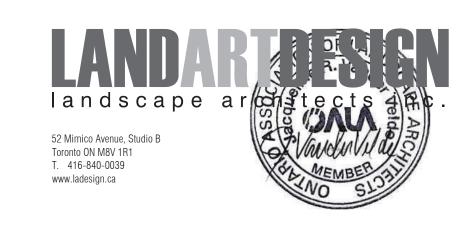

Architect - Sweeny & Co. Civil Eng - R. V. Anderson Associates Planner - Bousfields Inc. Mech Eng -Interior -

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REV DATE DESCRIPTION


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Green Roof Plans


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CHECKED BY: JVV
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LAD-519 04.05.2022



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NOTE: **Contractor shall provide alternative** pricing from all 3 suppliers. **BIOROOF**: 1 2 3 4


XEROFLOR:

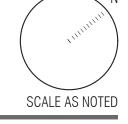L-303 L-303 L-303 L-303

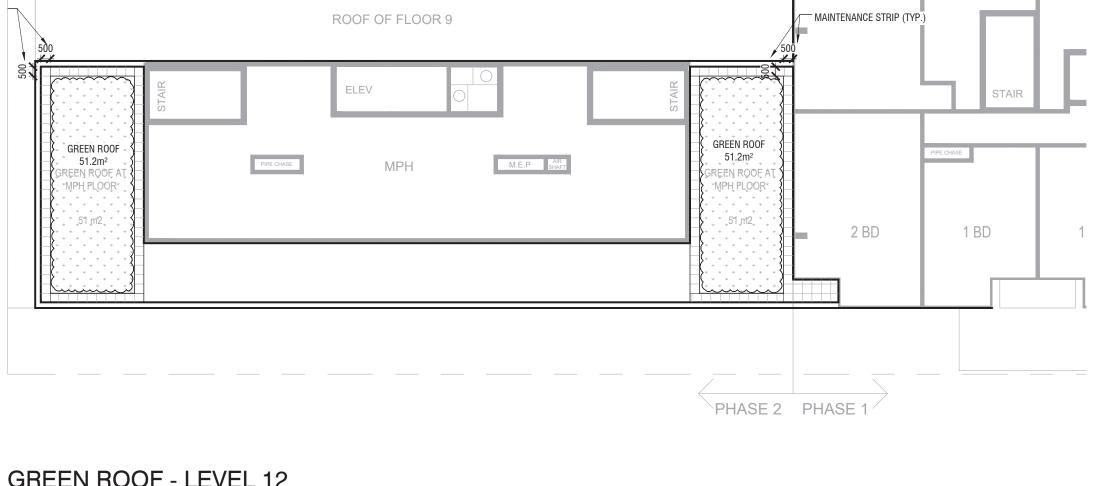

ZINCO:


.IIVU	U.			
1	2	3	4	5
L-304	L-304	L-304	L-304	L-304
6	7	8	9	10
L-304	L-304	L-304	L-304	L-304
11				
L-304				

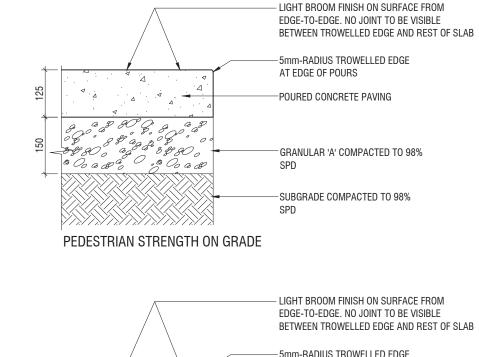

-5mm-RADIUS TROWELLED EDGE AT EDGE OF POURS POURED CONCRETE PAVING - Granular 'a' compacted TO 98% SPD ON FILTER MAT ON 100mm CLEAR STONE ON PROTECTION BOARD ON WATERPROOF MEMBRANE ON STRUCTURAL SLAB

PEDESTRIAN STRENGTH ON SLAB

PEDESTRIAN STRENGTH CONCRETE L-300 321313.01-03

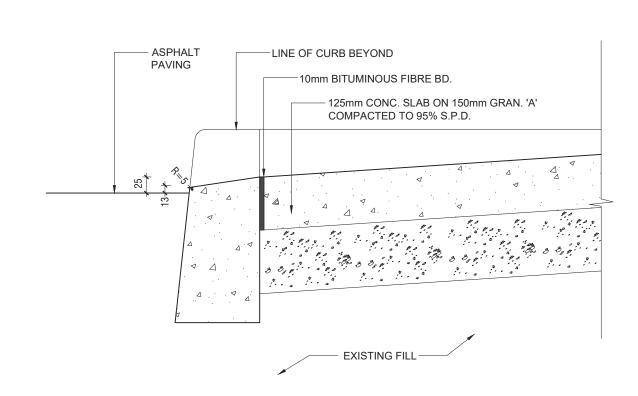

TYPICAL CURB CUT AND CONCRETE WALK L-300

> - 80mm UNIT PAVERS ON 25mm SAND SETTING BED ON 150mm GRANULAR 'A' COMPACTED TO 98% SPD ON ±250mm GRANULAR 'B' COMPACTED TO 98% SPD ON SUBGRADE COMPACTED TO 98% SPD

ON GRADE

- 80mm UNIT PAVERS ON 25mm SAND SETTING BED ON 150mm GRANULAR 'A' COMPACTED TO 98% SPD ON ±250mm GRANULAR 'B' COMPACTED TO 98% SPD ON FILTER FABRIC ON CLEAR STONE DRAINAGE COURSE (OR DRAINAGE LAYER) ON PROTECTION BOARD OVER WATERPROOFING ON SLAB

SLAB

ON SLAB

HEAVY-DUTY UNIT PAVING L-300

CONTRACTOR TO MOCK-UP IN-PLACE SAMPLE FOR APPROVAL. SAMPLE TO BE 2mx2m OR AS SPECIFIED BY LANDSCAPE ARCHITECT

HEAVY-DUTY CONCRETE

ON GRADE


ON SLAB


UNIT PAVING


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321401-03

L-300




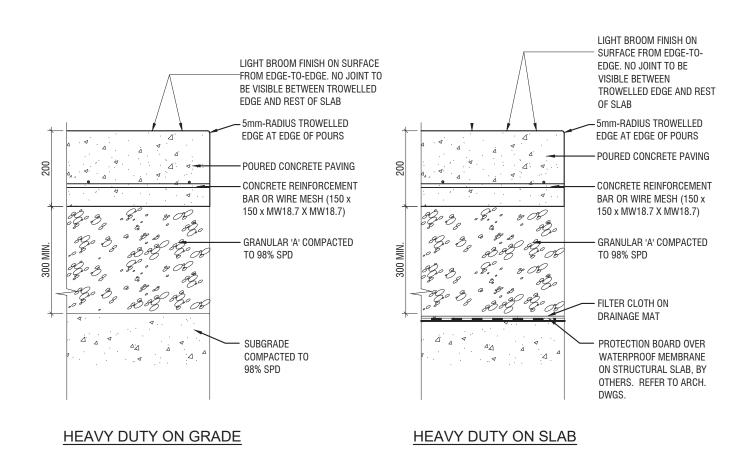

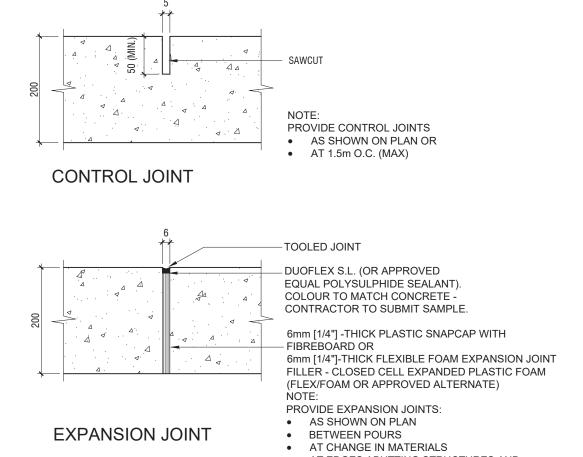


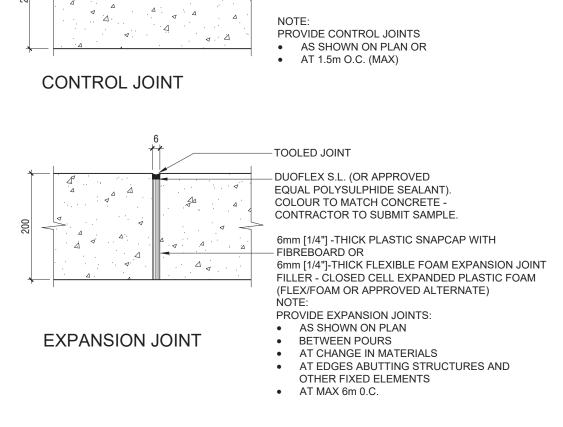



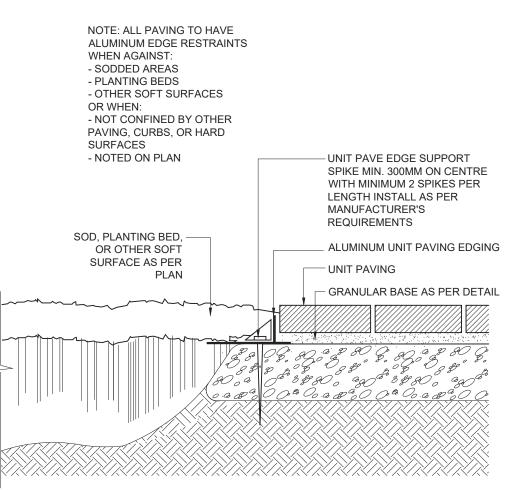



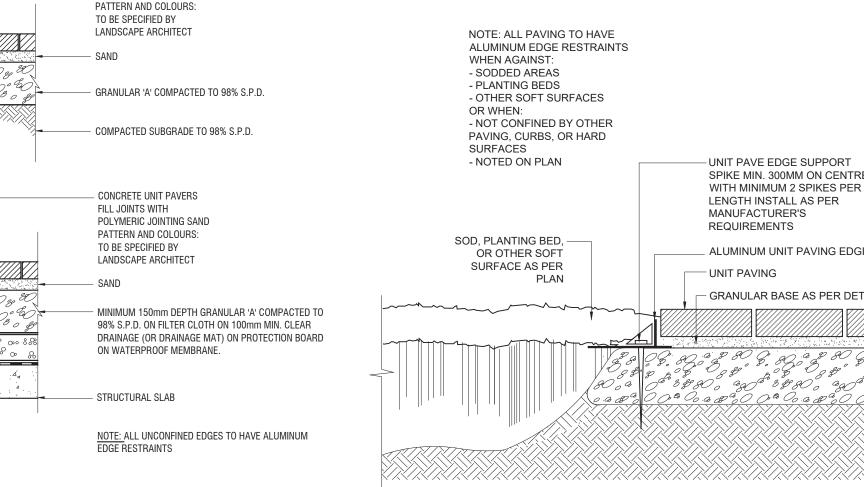



L-300 /

321313.01-12

CONCRETE UNIT PAVERS FILL JOINTS WITH POLYMERIC JOINTING SAND



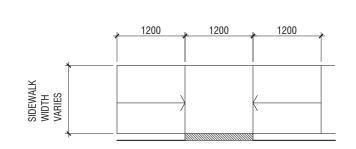

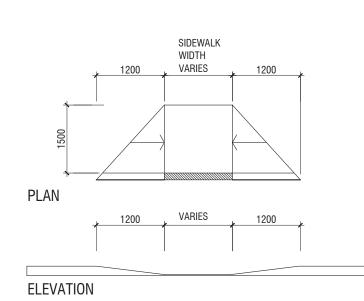


THE SURFACE TEXTURE OF THE RAMP SHALL BE COARSE BROOM FINISHED DRAINING TOWARDS THE GUTTER SO THAT IT IS ROUGHER THAN THE TEXTURE OF THE SURROUNDING SIDEWALK.





Detectable Warning Plates

Regulatory-compliant cast iron Detectable Warning Plates from Neenah Foundry offer appealing aesthetics, exceptional longevity and freedom from maintenance. By using Neenah's Detectable Warning Plates, specifiers can be confident that the critical warning message will be delivered for the lifetime of the installation.

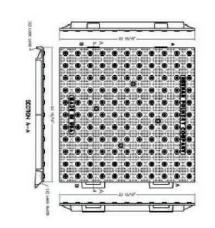


Quick Connect Plates


Depth x Width

24" x 24"

24" x 30"

24" x 36"

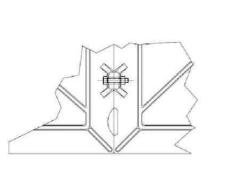

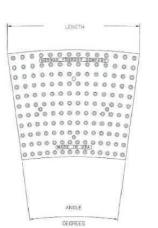

Radius Plates

321730.50-50

Bolted Plates

Wears Like Iron Because It Is Iron!
 Lasting form and function — we have never had one fail

Trouble Free Installation

Premium Material

Plates easily set in wet concrete

Low-maintenance cast gray iron

Integral lugs ensure solid attachment

Cap head screws can be added for extra anchorage

 Excellent wear resistance — virtually indestructible Cast iron far outlasts competitive substances

Natural patina provides ample visual contrast

Quick Connect Plates		Wears Like Iron Because It Is Iron!		
Depth x Width	Catalog No.	 Lasting form and function — we have never had one Installations with natural finish are maintenance-free 		
24" x 24"	4984-24Q	Highly resistant to snow plow and shovel damage		
24" x 30"	4984-30Q	 Lasting non-skid properties 		
24" x 36"	4984-36Q	 Excellent cast iron to concrete adhesion properties 		
		 No need for replacement features — our plates are p 		

No need for replacement features — our plates are permanent 5-yr limited warranty **Bolted Plates** Vent holes release gasses and air for maximum concrete Catalog No. Furnished lifting brackets simplify installation 4984-24B Can cover long runs using radius or straight sections

4984-30B

4984-36B

Radius Plates 9' 5" 4984-9-5R

4984-35R Guidelines for Accessible Rights-of-Way

The ADA and ABA have specific guidelines that refer to numerous issues concerning detectable warning. Neenah Foundry's Detectable Warning Plates help you meet these requirements.

Neenah recommends that specifiers review prevailing national, state and local guidelines to ensure full compliance. @ 2014 Neenah Foundry, all rights reserved.

TACTILE WALKING SURFACE INDICATOR L-300

GENERAL NOTES 1. All dimensions in millimetres (mm) 2. Verify all dimensions 3. Do not scale drawings 4. Check drawings against specifications 5. Use the latest revised drawings only 6. Report any discrepancies to the Landscape Architect before 7. Drawings and specifications are the property of the Landscape Architect, and must be returned upon completion of the work

52 Mimico Avenue, Studio B

Architect - Sweeny & Co.

Planner - Bousfields Inc.

proceeding

Civil Eng - R. V. Anderson Associates

Toronto ON M8V 1R1

T. 416-840-0039

www.ladesign.ca

Mech Eng -

Interior -

1 JUL.28.2022 Issued for ZBA/SPA

DESCRIPTION REV DATE

Paving Details


DRAWN BY: RH CHECKED BY: JVV PRINT DATE: Jul.29.2022


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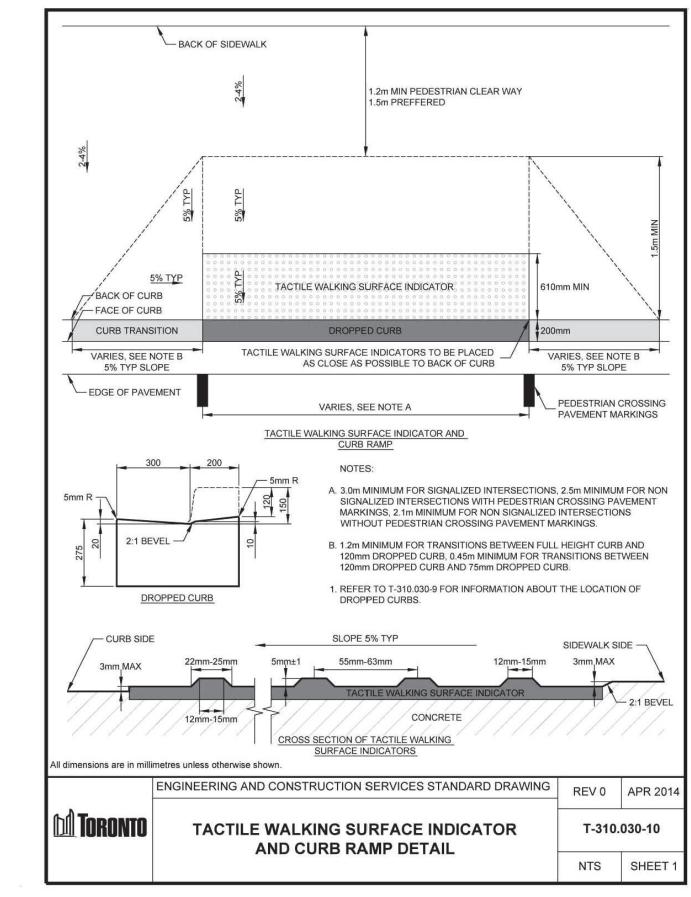


LAD-519

04.05.2022



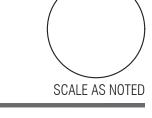

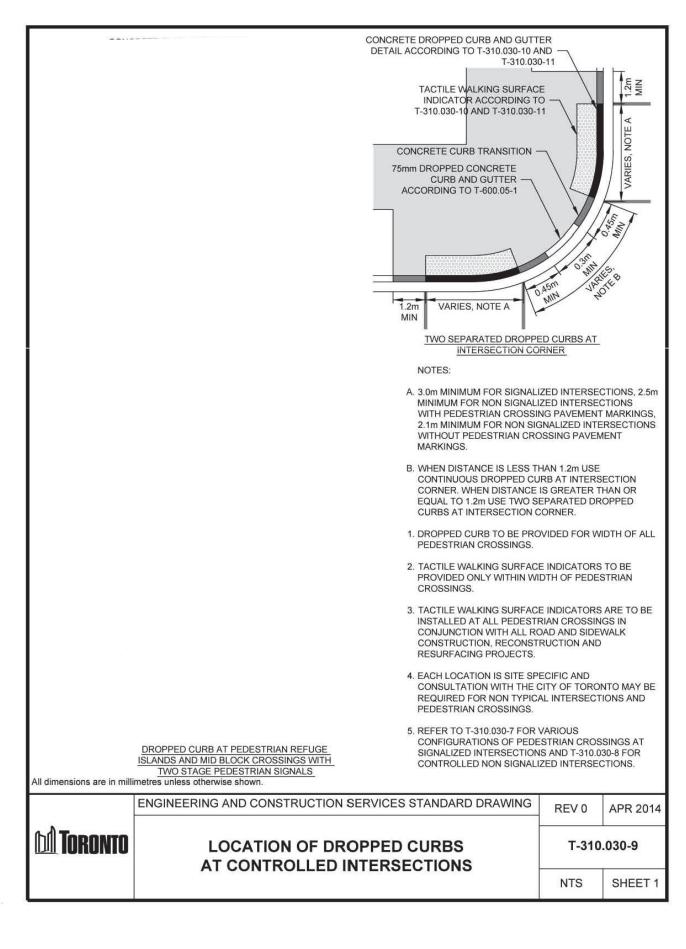

TACTILE SURFACE - CURB RAMP

25-50mm BARK MULCH


GROWING MEDIUM AS PER TS 5.10


-UNDISTURBED SUBGRADE, FIRMLY COMPACT ANY BACKFILLED SOIL TO ELIMINATE AIR POCKETS AND PREVENT SOIL SETTLEMENT

ENGINEERING & CONSTRUCTION SERVICES STANDARD DRAWING

PLANTING DETAILS

SHRUB AND HERBACEOUS PLANTING DETAILS

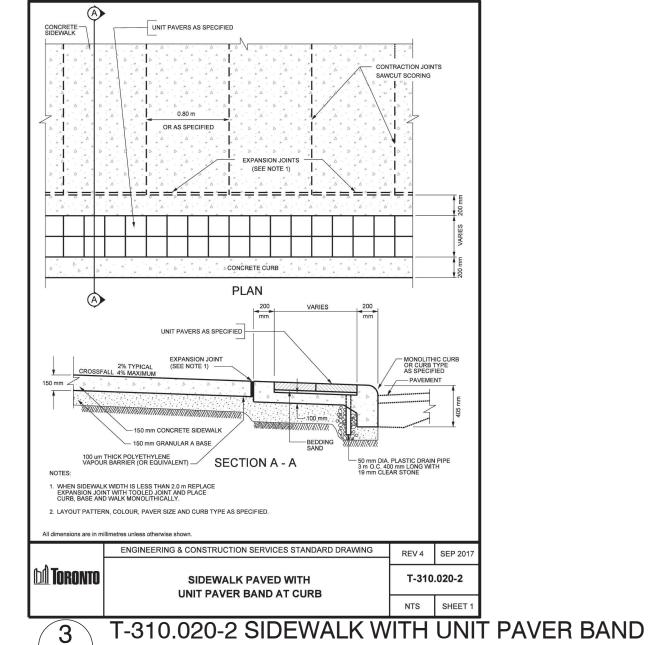

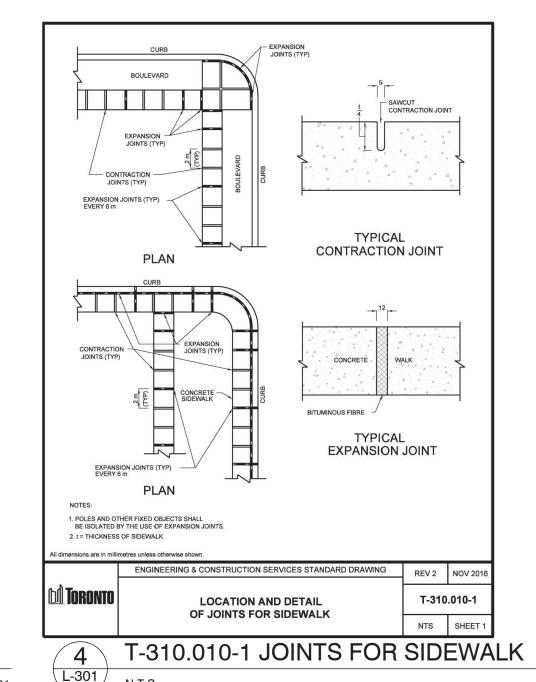



320101.31-09

L-301 /

320101.22-25

 REMOVE ALL DEBRIS AND CONTAMINATED SOIL FROM PLANTING SPACE PRIOR TO PLANTING. 2. TREE WILL BE POSITIONED WITH TRUNK FLARE SLIGHTLY (2-5cm) ABOVE FINAL GRADE AND STRUCTURAL ROOTS NEAR SURFACE. TOP OF ROOT BALL SHOULD NOT BE DISTURBED OR COVERED WITH SOIL. CONTRACTOR SHALL REMOVE EXCESS SOIL FROM THE TOP OF THE ROOT BALL TO EXPOSE ROOT FLARE PRIOR TO PLANTING TO ENSURE THAT THE BASE OF THE TRUNK FLARE IS FLUSH WITH THE ADJACENT GRADE AND PLUMB IN ALL DIRECTIONS. DIG PLANTING HOLE MIN. 60cm WIDER THAN THE WIDEST DIMENSIONS OF THE ROOT BALL. 4. TOP HALF OF ALL ROOT BALL PACKING AND WIRE TO BE CUT AND REMOVED OFF-SITE. CUT BURLAP AWAY. DO NOT FOLD DOWN.

5. GROWING MEDIUM SHOULD BE LIGHTLY TAMPED EVERY 15cm WHEN THE PLANTING HOLE IS BEING FILLED. ONCE § OF DEPTH OF PLANTING PIT HAS BEEN BACKFILLED. FILL REMAINING SPACE WITH WATER. ONCE WATER HAS PENETRATED GROWING MEDIUM, FILL TO FINISH GRADE. SOAK GROWING MEDIUM TO ENSURE FULL CONT

. 25-50mm HIGH SAUCER OF MULCH SHOULD BE ADDED ON TOP OF AND AROUND THE ROOT BALL TO A DEPTH NOT EXCEEDING 50mm AND SET A MINIMUM OF 40mm AWAY FROM ROOT FLARE/TRUNK. PRUNE TO REMOVE DEAD AND DAMAGED BRANCHES. DO NOT REMOVE LEADER. TREES WITH CO-DOMINANT STEMS WILL BE REJECTED. 8. REMOVE NURSERY TRUNK WRAP FROM TRUNK AND INSPECT FOR DAMAGE

 THOROUGHLY IRRIGATE ROOT BALL UPON INSTALLATION WITH A HOSE AND THEN INSTALL AND FILL DRIP IRRIGATION BAG (GATOR BAG OR EQUAL). IN ALL TREE OPENINGS, INSTALL TREE BARK PROTECTOR WITH A SIGN PROHIBITING BICYCLE LOCKING. SIGN MUST BE ATTACHED TO TREE BARK PROTECTOR USING PLASTIC ZIP TIES.

REMOVE ALL PACKAGING FROM THE TREE INCLUDING TAGS, TWINE, TAPE, ETC. IN CROWN OF TREE.

11. SCARIFY SIDES & BOTTOM OF PLANTING BED TO HELP WITH ROOT PENETRATION. 12. SEE PLANTING SPECIFICATION AND SOIL SPECIFICATION.

MIN. WIDTH 1.5m ENGINEERING & CONSTRUCTION SERVICES STANDARD DRAWING T-850.026-1 PLANTING DETAILS TREE PLANTING DETAILS 1:40 SHEET

TRUNK PROTECTOR SIGNAGE FOR TREES IN PAVING ONLY

NO SOIL ON TOP OF ROOT BALL

MULCH SAUCER 25-50mm BARK MULCH

GROWING MEDIUM AS PER


LOOSEN / SCARIFY BASE OF TREE PIT

UNDISTURBED/COMPACTED

5 T-850.260-1 TREE PLANTING DETAIL L-301

L-301

SHRUB AND HERBACEOUS PLANTING DETAILS 320101.11-02

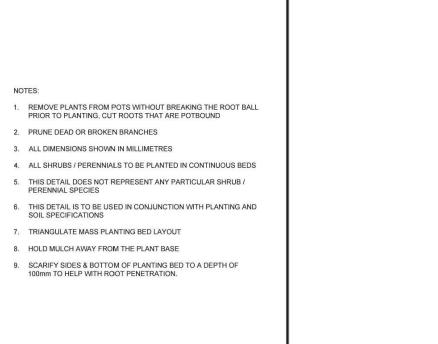

T-850.026-2

1:40 SHEET

320101.31-10

L-301 /

320101.10-31

1 JUL.28.2022 Issued for ZBA/SPA

REV DATE DESCRIPTION

320101.10-25

52 Mimico Avenue, Studio B Toronto ON M8V 1R1 T. 416-840-0039 www.ladesign.ca

Architect - Sweeny & Co.

Planner - Bousfields Inc.

GENERAL NOTES

2. Verify all dimensions 3. Do not scale drawings

Mech Eng -Interior -

Civil Eng - R. V. Anderson Associates

1. All dimensions in millimetres (mm)

4. Check drawings against specifications 5. Use the latest revised drawings only

6. Report any discrepancies to the Landscape Architect before

7. Drawings and specifications are the property of the Landscape

Architect, and must be returned upon completion of the work

City of Toronto Standard Details


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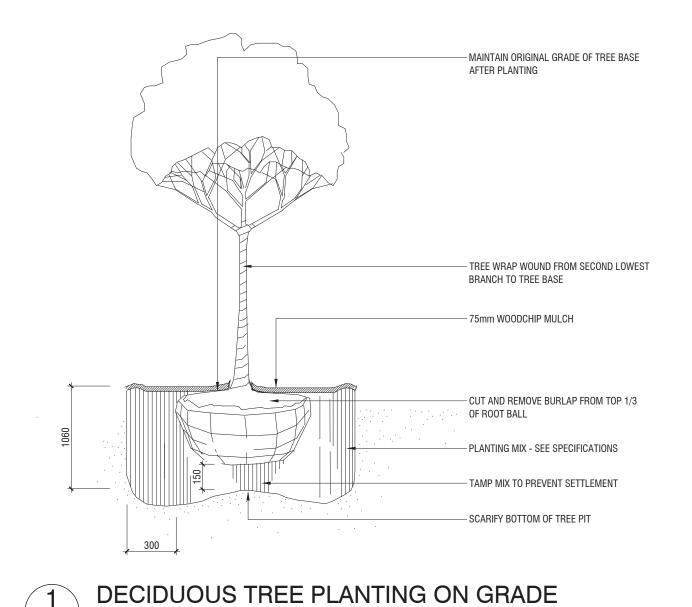
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HULLMARK


LAD-519


04.05.2022




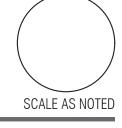

329343.01-07

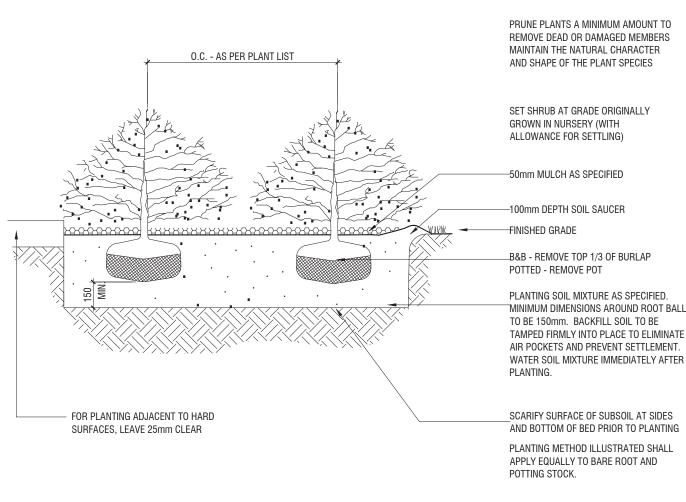


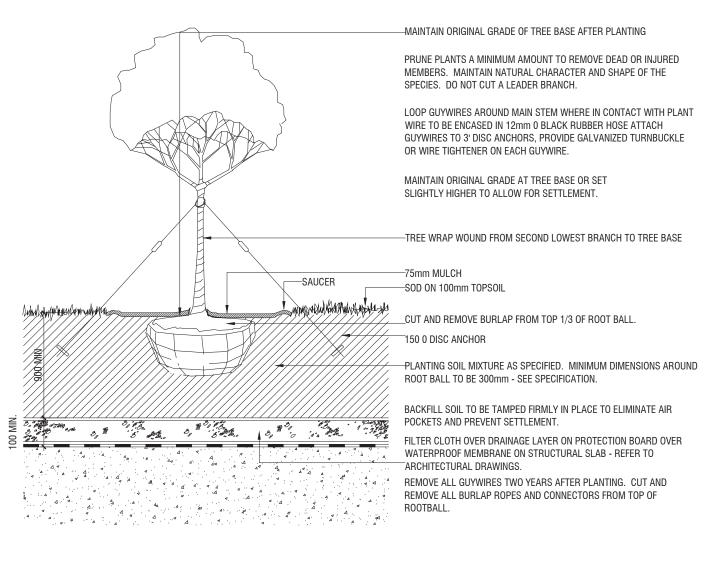

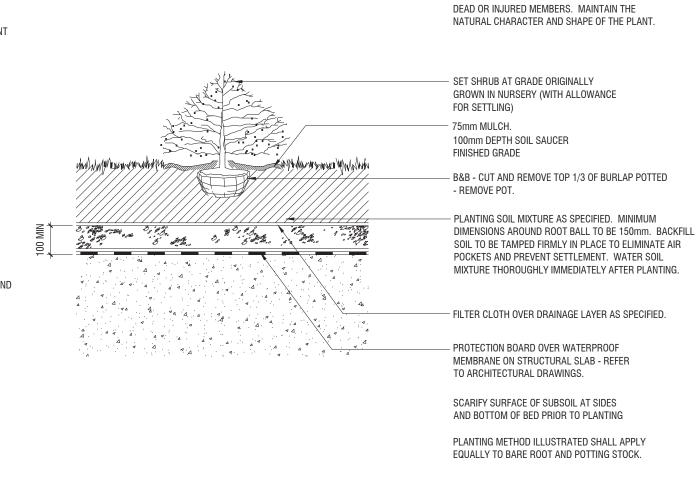

PRUNE PLANTS A MINIMUM AMOUNT TO REMOVE

329343.01-11

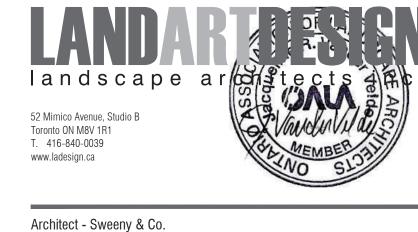

Civil Eng - R. V. Anderson Associates Planner - Bousfields Inc. Mech Eng -Interior -

GENERAL NOTES

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1 JUL.28.2022 Issued for ZBA/SPA

REV DATE DESCRIPTION

Planting Details

DRAWN BY: RH
CHECKED BY: JVV
PRINT DATE: Jul.29.2022


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Radiator TORONTO, ON

HULLMARK

LAD-519 04.05.2022


SCALE AS NOTED

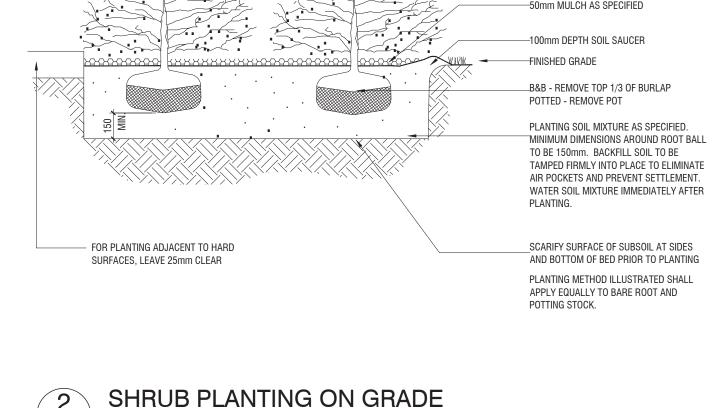



329333.01-10



SHRUB PLANTING ON SLAB

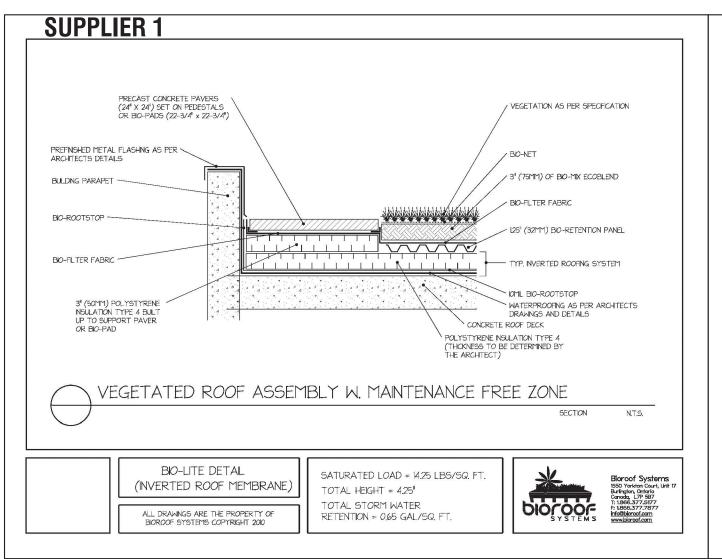

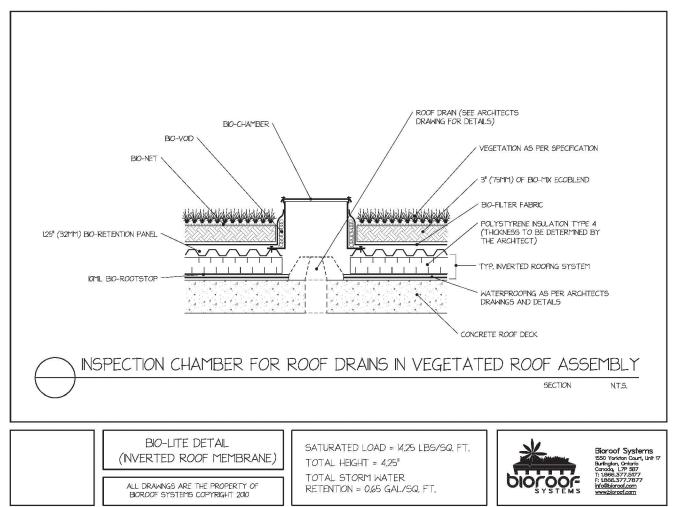

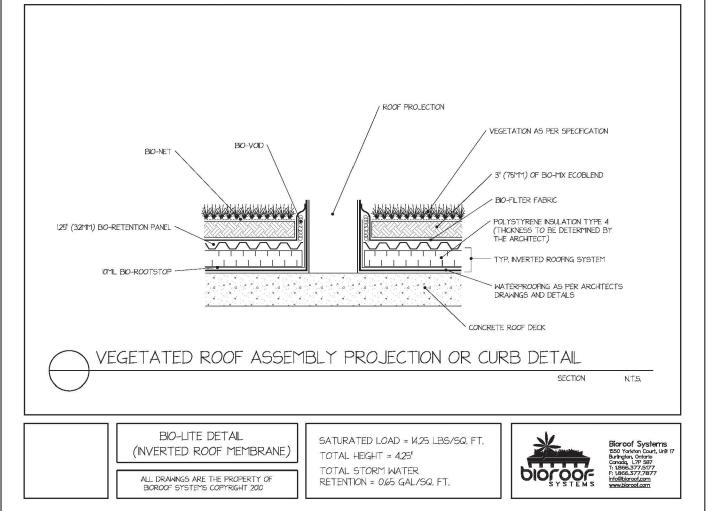


52 Mimico Avenue, Studio B Toronto ON M8V 1R1 T. 416-840-0039 www.ladesign.ca

Architect - Sweeny & Co. Civil Eng - R. V. Anderson Associates Planner - Bousfields Inc. Mech Eng -Interior -

GENERAL NOTES

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323210-51

323210-31

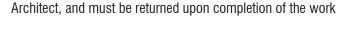
INSPECTION CHAMBER - INVERTED ROOF

L-303

323210-32

PROJECTION - INVERTED ROOF

323210-33

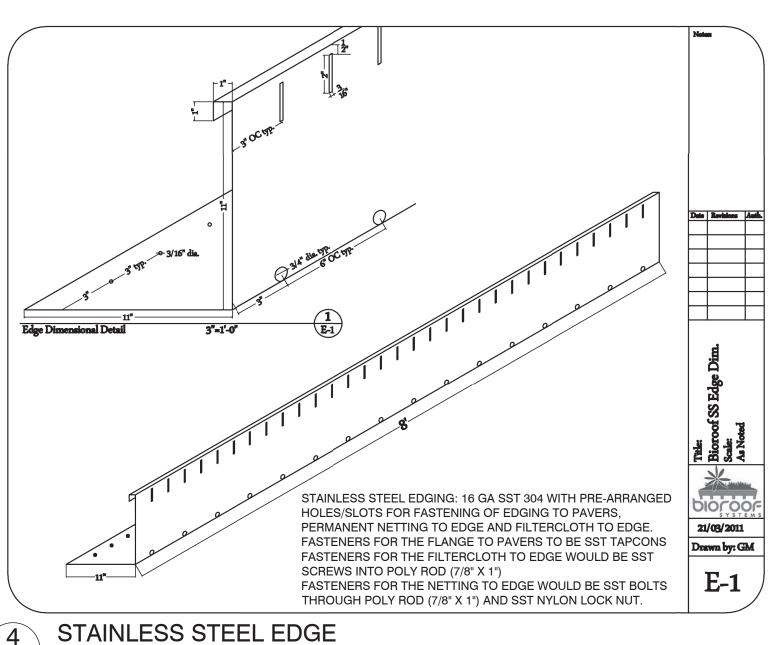


NOTE:

L-303

Contractor shall provide alternative pricing from all 3 suppliers. **Green Roof to be irrigated with potable** water. Drought-tolerant sedum planting to be used on 100% of Green Roof area. **Any Green Roof alternative shall satisfy** all wind uplift requirements and not exceed total depth specified for Alternative 3.

SUPPLIER 2

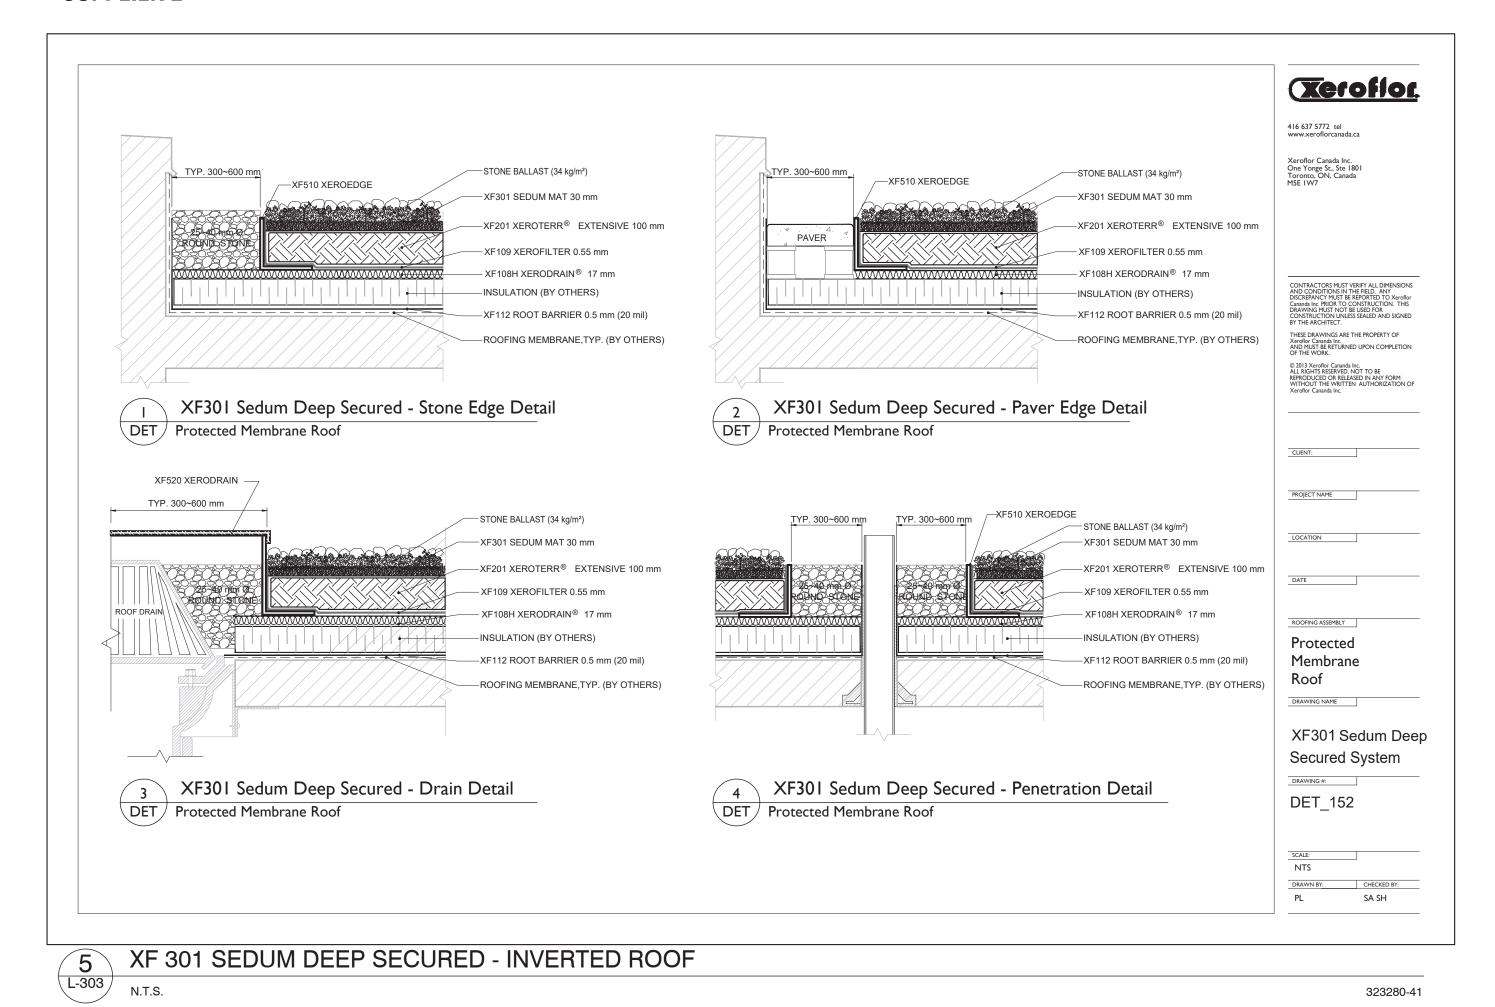

Green Roof Details - Suppliers 1 & 2

DESCRIPTION


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LAD-519 04.05.2022

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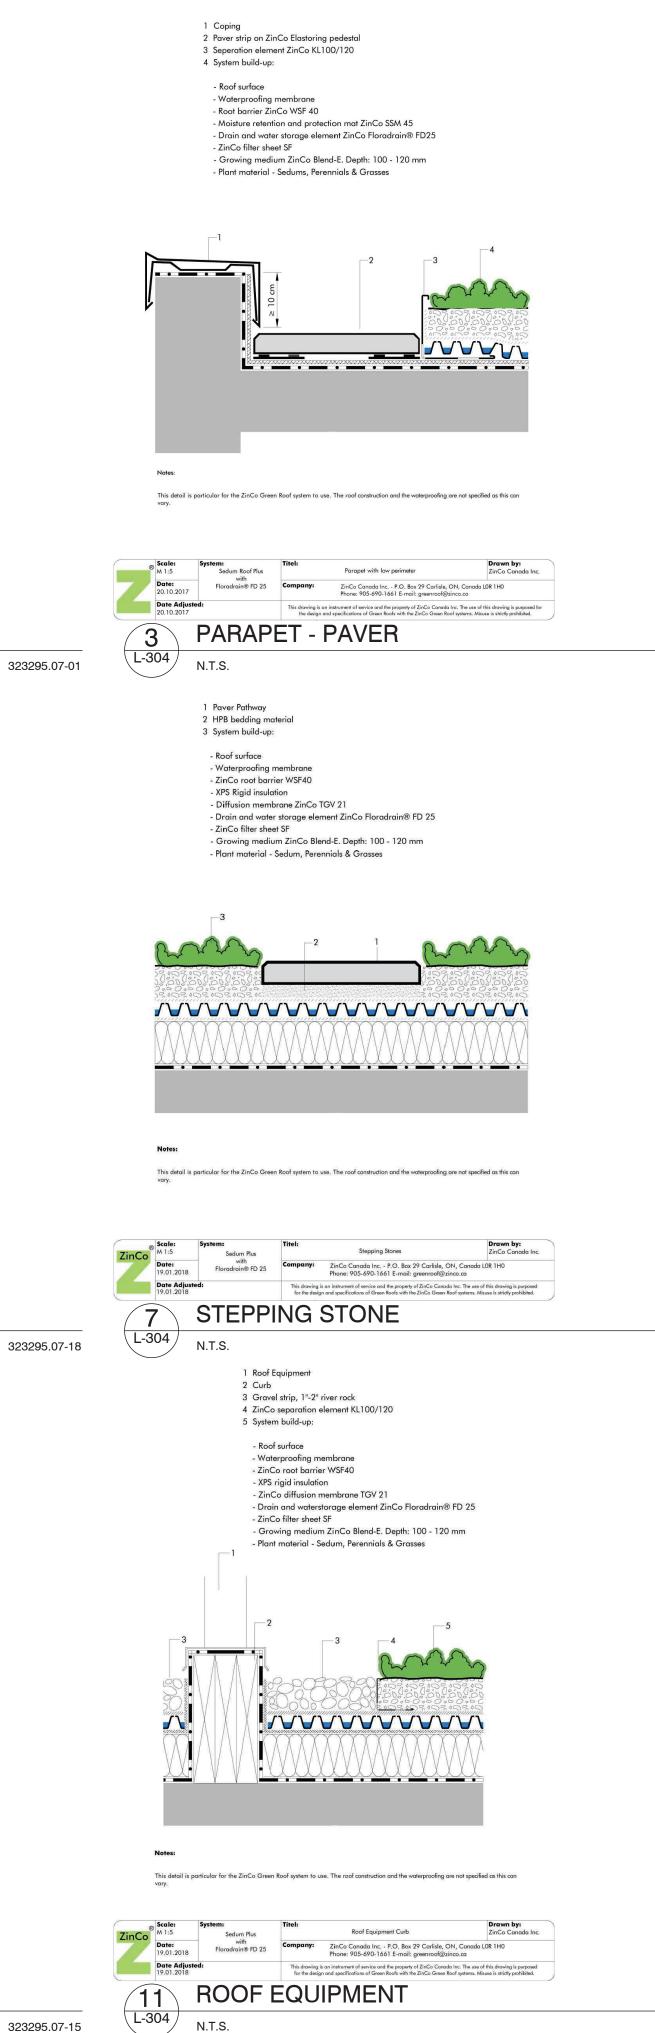


INITIAL

SUPPLIER 3

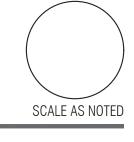

323295.07-14





52 Mimico Avenue, Studio B Toronto ON M8V 1R1 T. 416-840-0039 www.ladesign.ca

Architect - Sweeny & Co. Civil Eng - R. V. Anderson Associates Planner - Bousfields Inc. Mech Eng -Interior -

GENERAL NOTES

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NOTE:

323295.07-16

Contractor shall provide alternative pricing from all 3 suppliers. **Green Roof to be irrigated with potable** water. Drought-tolerant sedum planting to be used on 100% of Green Roof area. 1 JUL.28.2022 Issued for ZBA/SPA

Green Roof Details - Supplier 3

DESCRIPTION


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REV DATE

Radiator HULLMARK

LAD-519

04.05.2022

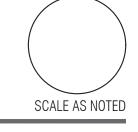

INITIAL